


Gene Friend Recreation Center

270 6th Street, San Francisco, CA 94103

PERMIT #: 202212168587 S

CD CONSTRUCTABILITY SET #1 (PRE 60% CD) **FEBRUARY 02, 2024**

193 SHEETS

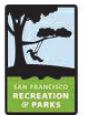



APPLICABLE CODES AND AGENCIES

CALIFORNIA CODE DE REGULATIONS (CCR)

2019 CALIFORNIA ADMINISTRATIVE CODE - PART 1, TITLE 24 (CAC)

2019 CALIFORNIA BUILDING CODE - PART 2, TITLE 24 (CBC)

2019 CALIFORNIA ELECTRICAL CODE - PART 3, TITLE 24 (CEC) 2019 CALIFORNIA MECHANICAL CODE - PART 4, TITLE 24 (CMC)

2019 CALIFORNIA ENERGY CODE - PART 6, TITLE 24 (CEC)

2019 CALIFORNIA FIRE CODE - PART 9, TITLE 24 (CFC)

2019 CALIFORNIA GREEN BUILDING STANDARDS CODE (CAL GREEN), PART 11, TITLE 24

2019 CALIFORNIA REFERENCED STANDARDS CODE 2019 SAN FRANCISCO CODE AMENDMENTS

SAN FRANCISCO ENVIRONMENT CODE, CHAPTER 7

2010 AMERICANS WITH DISABILITIES ACT STANDARDS (ADAS) FOR ACCESSIBLE DESIGN NFPA 13, STANDARD FOR THE INSTALLATION OF SPRINKLER SYSTEMS, 2019

FORTHCOMING SUBMITTALS

1. DEPARTMENT OF PUBLIC HEALTH

2. EARTHWORK, GRADING & SITE UTILITIES; GROUND IMPROVEMENT & PILES

3. FOUNDATION AND SUPERSTRUCTURE 4 ARCHITECTURE MEP AND LANDSCAPE

5. FIRE SUPPRESSION (DESIGN / BUILD)

6. FIRE ALARM (DESIGN / BUILD)

ALTERNATES

Add Alternate #1: Exterior Sliding gates at Egress Alcoves on Folsom & 6th Street

Add Alternate #2: Sliding Exterior Glass Wall to Storefront at Park Room

Deduct Alternate #1: Coreflex instead of Modernfold Acoustic Partition Divider Deduct Alternate #2: Gym Curtain Divider instead of Modernfold Acoustic Partition Divider

Deduct Alternate #3: Landscape Exercise Equipment Area: Fitness equipment and dividing wall to playground area Deduct Alternate #4: Supernova Exercise Equipment

PROJECT INFORMATION

PROJECT NAME GENE ERIEND RECREATION CENTER PROJECT ADDRESS 270 6TH STREET SAN FRANCISCO, CA 94103

PARCELS (LOT/BLOCK): 010/3731, 011/3731, 111/3731, 012/3731

ZONING P PUBLIC

PROPOSED USE NEW RECREATION CENTER WITH EXERIOR PARK OCCUPANCY GROUPS

PRIMARY: A3 - GYMNASIUM, MULTIPURPOSE ROOMS, EXERCISE ROOMS ACCESSORY: B - OFFICE

HEIGHT & BULK OS Open Space, determined by Master Plan

SPECIAL USE DISTRICTS Youth and Family Zone; Within 1/4 Mile of an Existing Fringe Financial Service PLANNING DEPT. HISTORIC RESOURCE STATUS C - NOT A HISTORIC RESOURCE

CONSTRUCTION TYPE TYPE III-B

LIFE SAFETY FULLY SPRINKLERED, PER NFPA 13 NO. OF FLOORS, HEIGHT 1 STORY, 38' SITE AREA 44.648 SF GROSS BUILDING AREA

24,810 SF AUTOMOBILE PARKING NONE LEED GOLD, MINIMUM

PROJECT DESCRIPTION

The Gene Friend Recreation Center project will develop a new, one-story building and an improved exterior park on the project site. The project site is located in the South of Market area of San Francisco, and is bordered by 6.th Street, Folsom Street, Harrief Street, and existing, privately owned buildings.

The project site currently houses a one-story building on the north, with exterior park to the south and west. The existing building and park will be demolished to allow construction of the new recreation center. The proposed development will locate the building words the southern part of the site part of center with existing sup-days sortburs. The outdoor recreation sere, including the prispround, will be located on the northern part of the site as configuous open space numming between 5° better and therefore the configuration of the site as configuous open space.

PROJECT DIRECTORY

OWNER
CITY OF SAN FRANCISCO, RECREATION AND PARKS DEPARTMENT
MCLAREN LODGE - 50 ISTANYAN STREET
SAN FRANCISCO, CA 94117
MAIN CONTACT: MELINDA SULLIVAN (MELINDA SULLIVAN (MESFGOV, ORG)

ARCHITECT
THE MARK CONJONERO ASSOCIATES + KUTH RANKERI ARCHITECTS JOINT VENTURE
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MAIN CONTACT: FELICIA DUNHAM (FELICIAD@CAVAGNERO.COM)

PROJECT MANAGEMENT
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SS SHORELINE DRIVE, SUITE 200
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650.482.8377
MAIN CONTACT: MIKE O'CONNELL (MOCONNELL@BKF.COM)

LANDSCAPE ARCHITECTURE
SAN FRANCISCO DEPARTMENT OF PUBLIC WORKS
BUILDING ESSION & CONSTRUCTION
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415.908.0555
AN FRANCISCO, CA 94103
MAIN CONTACT: MARGUERITE BELLO (MBELLO@MABSE.COM)

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415.588.400
MAIN CONTACT: GYIMAH KASALI (GKASALI@RUTHCHEK.COM)

MECHANICAL / PLUMBING ENGINEERING, PV ENGINEERING; BUILDING COMMISSIONING GUTTMANN & BLAVIOET CONSULTING ENGINEERIS GUTTMANN & BLAVIOET CONSULTING ENGINEERIS SHAPPING ENGINEERIS GUTTMANN & BLAVIOET GUTTMANN & GUTTMANN &

ELECTRICAL ENGINEERING: LOW VOLTAGE, TELECOM & SECURITY CONSULTING HRA CONSULTING ENGINEERS SEX MARKET STREET, SUITE 1113 SAN FRANCISCO, CA 94104 14:5773,DASS.
MAIN CONTACT: HAMID ARBABARAGHI (HAMID ARBABARAGHI (BHRAENG COM)

LIGHTING DESIGN
BANKS LANDL LIGHTING DESIGN
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SAN FRANCISCO, CA 94107
415 618 8055
MAIN CONTACT: MATTHEW LANDL (MATT@BANKSLANDL.COM)

AV CONSULTING, ACQUISTICAL ENGINEERING & NOISE ANALYSIS CHARLES NI SALTER ASSOCIATES, INC. 68 SOUTH HARRYST, SUITE 480 SAN JOSE CA 95113 402 295.494 402 295.494 403 CONTROL TO THE CONTROL OF THE CONTRO


IRRIGATION CONSULTANT:
BROOKWATER IRRIGATION CONSULTANTS
490 ST. JOHN STREET SUITE 220
PLEASANTON, CA 91566
925.855.0117
MAIN CONTACT: JANET LUEHRS (JANET@BROOKWATER.COM)

ROOFING / WATERPROOFING / EXTERIOR ENVELOPE WISS, JANNEY, ELSTNER ASSOCIATES, INC. 2009 POWEL STREET, SUITE 1650 EMERYVILLE, CA 94638 510.428.2007 MAIN CONTACT: ROBERT KERNS (RKERNS@WJE.COM)

115.971.4222 MAIN CONTACT: EMILY BORLAND (EB@EMILYBORLAND.COM)

COST ESTIBATING
TED COSSILITANTS
SESSILONETRE BLVD. 8154
ROCKIN. CA 98765
41 58720996
MAIN CONTACT: GARY HOLLAND (GHOLLAND@TEDCONSULTANTS.COM)

VICINITY MAP

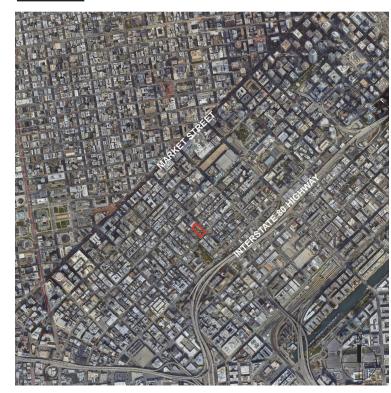

PROJECT LOCATION



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A10.1	RENDERINGS	•	
A10.2	RENDERINGS		
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3 STRUCT	TURAL		
S0.1	GENERAL NOTES		
S0.2	TYPICAL CONCRETE DETAILS		
S0.3	TYPICAL STEEL DETAILS		
S1.1	SITE PLAN		•
S2.1	FOUNDATION PLAN		
S2.2	LOW ROOF FRAMING PLAN		
S2.3	HIGH ROOF FRAMING PLAN		
S3.1	BUILDING SECTIONS		
S3.2	NORTH SOUTH BRACE LINE ELEVATIONS		
S3.3	EAST WEST BRACE LINE ELEVATIONS		
S4.1	ENLARGED BRACE ELEVATIONS		
S4.2	ENLARGED BRACE ELEVATIONS		
S5.1	GRADE BEAM SECTIONS		

M0.1	LEGEND, SYMBOLS, GENERAL NOTES & DRAWING LIST		•	١.
M0.2	TITLE-24 CALCULATIONS		•	г
M0.3	TITLE-24 CALCULATIONS		•	-
W0.4	TITLE-24 CALCULATIONS		•	Γ,
M2.0	LEVEL 1 - HVAC		•	г
M2.1	ROOF PLAN - HVAC		•	г
M2.2	LEVEL 1 - REFRIGERANT PIPING		•	Γ,
M2.3	ENLARGED PLANS		•	٦,
M2.4	ENLARGED PLANS		•	T-
M3.1	SECTIONS		•	г
M3.2	SECTIONS	\neg	•	Γ.
M3.3	SECTIONS		•	Γ.
M4.1	DETAILS		•	٦,
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M4.4	DETAILS	\neg	•	Γ.
M4.5	DETAILS		•	г
M4.6	DETAILS		•	1
M5.1	SCHEDULES		•	1
M5.2	SCHEDULES		•	١,
M5.3	SCHEDULES		•	

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	SITE PERMIT: RESPONSE TO DBI COMMENTS	SITE PERMIT: RESPONSE TO BSM COMMENTS		ILITY SET #1				
DESCRIPTION	SITE PERMIT: RESI	SITE PERMIT: RESI	CD PROGRESS SET	CD CONSTRUCTABILITY SET #1				
DATE	8.10.2023	11.15.2023	12.14.2023	2.2.2024				
REV	9		8	6				
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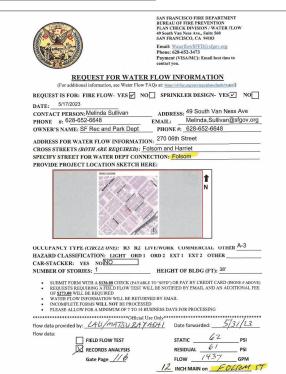
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Center

Recreation Friend Gene

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SFFD FIRE FLOW INFORMATION



&	And Angle	FTG. FURR.	Footing Furring
@ (L	Angle At	FUT	Future
(L (C	Centerline Copyright	F.V.C.	Fire Valve 0
0	Degrees	GA.	Gauge
Ø	Degrees Diameter	GALV.	Galvanized
# S.F.	Number or Pound	G.B.	Grab Bar
±	Square Feet Plus or Minus	G.C.	General Co Garbage Di General
FL	Property Line	GEN.	General
ABV.	Ahove	GFCI GFRC	
A/C. ACOUS.	Air Conditioning	GRG	Glass Fiber Glass Reint
ACOUS.	Acoustical	GL. G.N.	Glass
A.D. ADA	Area Drain Americans W/ Disabilities Act	G.N. GND.	General No
ADDI	Additional Adjustable or Adjacent	G.R.	Ground Guard Rail
ADJ. A.F.F.	Adjustable or Adjacent Above finished floor	GR.	Grade
AGGR	Andregate	GYP.	Gypsum Bo
AL.	Aggregate Aluminum	H.B.	Hose Bib
A.P. APPROX.	Access Panel Approximate	H.C. HCP.	Hose Bib Hollow Con Handicappe
ARCH.	Architectural	HCP.	Handicappe Head
AUTO	Automatic	HD. HDBD.	Hardhoard
an.	Board	HDR.	Header Hardware
BEL.	Relow	HDW. HDWD.	Hardware Hardwood
BLDG	Ruilding	HT.	Heinht
BLK. BM.	Block Beam	H.M. HNDRL.	Hollow Met
3.0.	Bottom Of	HOR	Handrail Horizontal
	Bottom	H.PT.	High Point Handrail
BRKT. BRG.	Bracket Bearing	H.R. HR	Handrail
BRK.	Brick	HR. H.V.A.C.	Hour Heating, Ve Condition
3.U.R.	Built-up Roofing		Conditio
BSMT.	Basement	H.W.	Hot water
C.	Carpet	LD.	Inside Diam
CAB. CAT.	Cabinet Category	IN	Inch
DAT.			Incandesce Include(d) (
CB. CEM.	Cement Ceramic	INCL. INFO.	Include(d) (
	Ceramic	INSUL.	Insulation
C.G. C.I.P.	Corner Guard Cast in Place	INT.	Interior Intermediat
C.J. CLG.	Control Joint	INTER.	Intermediat
CLG.	Control Joint Ceiling		
CLKG. CLO.	Caulking Closet	J-BOX JAN.	Junction Bo Janitor
CLR.	Clear	JST.	.loist
C.M.U.	Concrete Masonry Unit	JT.	Joint
CNTR.	Counter Canad Opening	KIT.	Kitchen
0.0. DOL.	Cased Opening Column	KII.	
	Concrete	L.	Length Laminate
CONSTR.	Construction Continuous	LAM. LAV.	Laminate
CONTR	Contractor	LG. L.F.	Lavatory Long
CORR	Corridor	L.F.	
OPT.	Carpet Cold Rolled Ceramic Tile	L.PT. L.T.	Low Point Light
iri. I.R. I.T.	Ceramic Tile	LT.FIXT.	Light Fixture
TR.	Center Curtain wall		
CW.	Curtain wall	M. MM	Meter
DBL.	Double	MACH	Millimeter Machine
)FPT	Department Detail	MANINIT	Maintenanc
ET./DTL.	Detail Drinking Fountain	MAT. MAS.	Material Masonny
DIA. DIM.	Drinking Fountain Diameter	MAX. M.D.F.	Masonry Maximum Medium De
DIM. DISP		M.D.F.	Medium De
NSP. I.N.	Dispenser Door Note	MECH. MEMB.	Mechanical Membrane
าเม	Down	MED	Mechanical
0.0.	Down Door Opening	MET./MTL	Metal
D.P. DR.	Dimension Point Door	MFR. MID	Manufactur Middle
ORN.	Danie	MIN.	Minimum
ns	Downspout	MISC.	Miscellaneo
D.W. DWG(S)	Dishwasher Drawing / Drawings	M.O. MTD.	Miscellaneo Masonry Or Mounted
DWR.	Downspout Dishwasher Drawing / Drawings Drawer	MUL.	Mullion
E.			
E. (E)	East Existing	N. (N)	North New
EA.	Each	N.I.C.	
I.J.	Expansion Joint	NO. NOM.	Number
L. LEC.	Elevation Electrical	NOM. N.T.S.	Nominal Not To Sca
ELEV.	Elevator		
EMED	Emernency	O.A. O.C.	Overall
NCL. NGR.	Enclosure	O.C. O.D.	On Center
ENGR. E.P.	Engineer Electrical Panelboard	O.D. O.F.C.I.	Outside Dia Owner Furn
EPDM	Ethylene Polypropylene (elastic plastic flashing)		
EQ.	(elastic plastic flashing)	OFD. OFL.	Overflow D
CODT		0FL. 0.F.O.I.	Owner Furn
EXP. EXPO.	Equipment Expansion		Overflow Do Overflow Le Owner Furr Installed
XPO.	Exposed Existing	OFF.	
XST.	Existing Exterior	O.H.	Overhead Opening
		OPNG. OPP.	Opposite
Α.	Fire Alarm	OPP. HD.	Opposite Opposite H Oriented St
D. ND.	Floor Drain OR Fire Damper	OSB OVHD.	Oriented St Overhead
	Fire Extinguisher		
E.C.	Formulation Fire Extinguisher Fire Extinguisher Cabinet Flat Head OR Full Height	P. PAV.	Paint Paving
H.	Flat Head OR Full Height	D.C	Prenast Co.
:uc			
HC	Fire Hose Cabinet	PERP.	Perpendicu
F.H.C. FIN. FIXT	Fire Hose Cabinet Finish Fixture	PERP. P.G.	Perpendicu Point Grade
F.H.C. FIN. FIXT. FL/FLR.	Fire Hose Cabinet Finish	PERP. P.G. PL. P.LAM.	Perpendicu Paint Grade Plate Plastic Lam

SYMBOLS

Tree At Tries At Tree At Tree At Tree At Tree At Tongue and Groove Tongue and Converting to the Attendance Att

West OR Width With Water Closet Wood Window Wood Flooring Water Heater Without Waterproof Work Point Work Point Weisstand Weight Weight Weight Weight Weight Weight Weight Weight Weight With With Weight Wei

ELEVATION	
A101 B	DRAWING NUMBER
BUILDING SECTION	INDICATES SHEET NUMBER
1 A101	DRAWING NUMBER SHEET NUMBER
WALL SECTION_	SHEET NUMBER
	DRAWING NUMBER
DETAIL KEY	SHEET NUMBER
1 A101	DRAWING NUMBER
KEYNOTE	SHEET NUMBER
4 XXXXXX	KEYNOTE REFERENCE, SEE KEYNOTE LEGEND
TYP. ALIGN	BUILDING ELEMENT ALIGNMENT
INTERIOR ELEVATION A 1 A101 B	DRAWING NUMBER DRAWING NUMBER SUBGROUP
ROOM NAME & NUMBER	SHEET NUMBER
Room name 101 150 SF	- ROOM NAME - ROOM NUMBER - ROOM AREA
WALL TAG	DOOR NUMBER DOOR SECURITY DOOR HARDWARE GROUP
	PARTITION TYPE PARTITION FIRE RATING STUD SIZE ADDITIONAL NOTE

GENERAL NOTES

1. THE CONTRACT DOCUMENTS INCLUDE THE WORKING DRAWINGS, PROJECT MANUAL, ADDENDA, MODIFICATIONS, AND THE CONDITIONS OF THE CONSTRUCTION CONTRACT.

2. THE CONTRACT DOCUMENTS ARE THE INSTRUMENTS OF SERVICE AND SHALL REMAIN THE PROPERTY OF THE ADDENTIFY CHEETER THE PROJECT FOR WHATH THE APPROPRIATE DOCUMENTS ARE THE INSTRUMENTS OF SERVICE AND SHALL REMAIN THE PROPERTY OF THE ADDENTIFY CHEETER THE PROJECT FOR WHATH THE APPROPRIATE DOCUMENTS ARE THE OFFICE OFFI WHATH THE APPROPRIATE DOCUMENTS ARE THE OFFI CHEETER AND PROJECT OF THE APPROPRIATE OFFI CHEETER AND PROJECT OF THE APPROPRIATE COMPRISATION TO THE APPORTER PROJECTS OR EXTENSIONS TO THE PROJECT ON ARE THE YES OFFI CONTRACT OF THE APPORTANT OF

3. ALL WORK SHALL COMPLY WITH THE APPLICABLE CODES, AMENDMENTS, RILLES, REGULATIONS, ORDINANCES, LAWS, ORDIERS, APPROVALS, ETC., THAT ARE REQUIRED BY PUBLIC AUTHORITIES IN OTHER OWN THAT OF CONTRICT OCCURRENT STORY OF CONSTRUCTION OF CONTRICT OR STORY OF CONTRICT OF CON

4. EXAMINATION OF THE SITE AND PORTIONS THEREOF WHICH WILL AFFECT THIS WORK SHALL BE MADE MADE AND ADDRESS OF THE CONTRACT ON THE CONTRACT DOLUMENTS AND WILL BE FROM THE CONTRACT OF THE CONTRACT OF

6. CONTRACTOR SHALL EXERCISE EXTREME CARE AND PRECAUTION DURING CONSTRUCTION OF THE WORK TO MINIMIZE DISTURBANCES TO ADJACENT STRUCTURES AND THEIR OCCUPANTS, PROPERTY, PUBLIC THOROUGH-FARES, ETC. CONTRACTOR SHALL TAKE PRECAUTIONS AND BE RESPONSIBLE FOR THE SAFETY OF ALL BUILDING OCCUPANTS FROM CONSTRUCTION PROCEDURES.

7. ALL CONTRACT DOCUMENTS ARE COMPLEMENTARY, AND WHAT IS CALLED FOR BY ANY WILL BE BINDING AS IF CALLED FOR BY ALL ARY WORK SHOWN OR REFERRED TO ON ANY CONTRACT DOCUMENTAL BEFORE TO THE ARY WORK SHOWN OR REFERRED TO ON ANY CONTRACT DOCUMENTAL BY A SHOWN OF THE ARY WORK SHOWN OR SHOWN OF THE ARY WORK SHOWN OR SHOWN OR SHOWN OR SHOWN OF THE ARY WORK SHOWN OR SHOW 8. CONTRACTOR SHALL PROVIDE MANUFACTURER S SPECIFICATIONS, INSTALLATION INSTRUCTIONS, SHOP DRAWNINGS AND SAMPLES FOR REVIEW OF ALL MATERIALS AND METHODS TO BE USED PRIOR TO ORDERING OR PROJECTION WITH THE WORK, ANY REQUEST FOR SUBSTITUTION SHALL BE SUBMITTED TO ARCHITECT FOR REVIEW IN COMPLANCE WITH SPECIFICATION SECTION NUMBER AND SHALL NOT BE PROCESSED OR SHATLED WITHOUT TERM RIVETED FERDINGS.

12. "OWNER" MEANS SAN FRANCISCO RECREATION AND PARK DEPARTMENT. 13. "FURNISH" MEANS SUPPLY ONLY, FOR OTHERS TO PUT IN PLACE.

14. "INSTALL" MEANS SUPPLIED BY OTHERS, TO BE INSTALLED BY CONTRACTOR.

15. "PROVIDE" MEANS FURNISH AND INSTALL, COMPLETE AND IN PLACE.

16. "SIMILAR" MEANS COMPARABLE CHARACTERISTICS FOR CONDITIONS NOTED. CONTRACTOR TO VERIFY DIMENSIONS AND ORIENTATION.

17. "TYPICAL" MEANS IDENTICAL FOR CONDITIONS NOTED.

20. DIMENSIONS NOTED ON DRAWINGS SHALL TAKE PRECEDENCE OVER SCALED DIMENSIONS. DETAIL
DRAWINGS TAKE PRECEDENCE OVER DRAWINGS OF SHALLER SCALE SHOULD THE CONTRACTOR AT ANY
THE DEDOCHET A HERORY BY A DIAWNING OF SEPCIFICATION OF A BOSCHEAPTOR OF WHACHTON
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A MERICAN SCOLETY FOR THE FOR THE

21. ALL WORK LISTED, SHOWN, OR IMPLIED ON ANY CONSTRUCTION DOCUMENTS SHALL BE PROVIDED BY THE CONTRACTOR, EXCEPT WHERE NOTED OTHERWISE. THE GENERAL CONTRACTOR SHALL CLOSELY CONCIONANTE HIS WORK WITH THAT OF OTHER CONTRACTOR OF VENDORS TO SASIME THAT ALL SOLEDLES ARE MET AND ALL WORK IS DONE IN CONFORMANCE TO MANUFACTUREN'S REQUIREMENTS & REQUIREMENTS OF THE DOCUMENTS.

22. CONTRACTOR SHALL MAINTAIN A CURRENT AND COMPLETE SET OF CONSTRUCTION DOCUMENTS ON THE JOBSTIE DURINGS ALL PHASES OF CONSTRUCTION FOR USE OR ALL TRADES AND SHALL PROVIDE SUBCONTRACTORS WITH CURRENT CONSTRUCTION DOCUMENTS.

23. THE CONTRACTOR SHALL BE RESPONSIBLE FOR THE DEVELOPMENT, COORDINATION, AND EXECUTION OF CONSTRUCTION METHODS & PROCEDURES.

24. THE CONTRACTOR SHALL BE RESPONSIBLE FOR INITIATING, MAINTAINING, AND SUPERVISING ALL SAFETY PRECAUTIONS & PROGRAMS IN CONNECTION WITH HIS WORK.

25. CONTRACTOR SHALL BE RESPONSIBLE FOR CORRECTION OF WORK AT HIS OWN EXPENSE FOR WORK INSTALLED IN CONFLICT WITH THE CONTRACT DOCUMENTS.

26. THE CONTRACTOR IS RESPONSIBLE FOR VERIFYING THE DIMENSIONS AND ELEVATIONS AT THE SITE. THE CONTRACTOR AND SUB-CONTRACTORS SHALL COORDINATE THE LAYOUT AND DAGOT LOCATION OF ALL PARTITIONING, DOORS, ELECTRICAL/TELEPHONE OUTLETS, LIGHT SWITCHES AND THERMOSTATS WITH THE ARCHITECT IN THE FIELD BEFORE PROCEEDING WITH CONSTRUCTION.

27. CONTRACTORS SHALL REMOVE ALL RUBBISH AND WASTE MATERIALS ON A REGULAR BASIS, AND SHALL EXERCISE STRICT CONTROL OVER JOB CLEANING TO PREVENT ANY DIRT, DEBRIS, OR DUST FROM AFFECTING, IN ANY WAY, FINISHED AREAS NO USTSIE JOSSIES.

28. CONTRACTOR SHALL LEAVE PREMISES AND ALL AFFECTED AREAS CLEAN AND IN AN ORDERLY READY FOR MOVE IN. THIS IS TO INCLUDE CLEANING OF ALL GLASS (INCLUDING INSIDE OF EXTERIOR GLASS) AND FRAMES, BOTH NEW AND EXISTING

29. THE CONTRACT DOCUMENTS ARE PROVIDED TO LLUSTRATE THE DESIGN AND GENERAL TYPE OF CONSTRUCTION, MATERIAL, AND WORKMANSHEP THROUGHOUT. THE DOCUMENTS DO NOT ILLUSTRATE EVERY CONDITION. THE CONTRACTOR, IN ASSUMING RESPONSIBILITY FOR WORK INDICATED, SHALL COMPLY WITH THE SPRINT AS WELL AS THE LETTER IN WHICH THEY WERE WRITTEN.

30. COORDINATE AND PROVIDE APPROPRIATE STRUCTURAL BLOCKING/BACKING AND REINFORCING IN PARTITIONS BEHIND ALL WALL MOUNTED ITEMS.

31. GENERAL CONTRACTOR SHALL BE RESPONSIBLE FOR CHECKING CONTRACT DOCUMENTS, FIELD CONDITIONS AND DIMENSIONS FOR ACCURACY AND CONFIRMING THAT WORK IS AS SHOWN BEFORE PROCEEDING WITH CONSTRUCTION. CLARIFICATIONS REGARDING ANY CONFLICTS SHALL BE ACHIEVED PRIORIC TO RELIED WORK BEINS STRATED.

33. MATERIALS EXPOSED IN RETURN AIR PLENUMS MUST MEET THE SPECIFIC REQUIREMENTS FOR SUCH AN APPLICATION IN NATIONAL ELECTRICAL CODE AND THE UNIFORM MECHANICAL CODE. THIS INCLUDES THE TELEPHONE AND COMPUTER CABLES

OR NEGLECT ON HIS PART TO MAKE SUCH EXAMINATION. ANY DISCREPANCIES SHALL BE REPORTED TO ARCHITECT BEFORE PROCEEDING WITH ANY WORK.

5. CONTRACTOR SHALL PROTECT AREA AND NEW OR DISTING MATERIALS AND FINISHES FROM DAMAGE WHITE HOUSE CONTRACTOR SHALL PROTECT AREA AND NEW OR DISTING MATERIALS AND FINISHES FROM DAMAGE WHICH HAVE COLOR FROM CONSTRUCTION, BUILDING USES AN EXCELLENGE OF THE PUBLIC DURING THE PEPRO OF OMERSTANDING SHALL DISTING HAVE PROVIDED ANY TEMPORARY BARRICAGES OR BEACQUES AND FINISHES, STRUCTURES, AND EXCELLENGE OF PROVIDED AND FINISHES. STRU

38. ATTACHMENTS, CONNECTIONS, OR FASTENINGS OF ANY NATURE ARE TO BE PROPERLY AND PERMANENTLY SECURED IN CONFORMANCE WITH BEST PRACTICE AND THE CONTRACTOR IS RESPONSIBLE FOR IMPROVING THEM ACCORDING TO THESE CONDITIONS.

MUL BE RESONABLE FOR BIRMOVING THE BALCHARM TO THESE COMMITTIONS.

TO COMMENTS OR NO WORK DEFECTION OR CONMENTS OR DRAWNINGS AND SPECIFICATIONS WILL BE ACCEPTABLE IN CONSEQUENCE OF OWNER'S OR DRAWNINGS AND SPECIFICATIONS WILL BE ACCEPTABLE IN CONSEQUENCE OF OWNER'S OR DRAWNINGS AND SPECIFICATIONS OF THE CONSTRUCTION OF THE CONTROL OF

41. CONTRACTOR SHALL WAIVE "COMMON PRACTICE" AND "COMMON USAGE" AS CONSTRUCTION CRITERIA WHEREVER DETAILS AND CONTRACT DOCUMENTS OR GOVERNING CODES, ORDINANCES, ETC., REQUIRE GENETER QUARTITY OR BETTER QUALITY THAN COMMON PRACTICE OR COMMON USAGE WOULD REQUIRE.

42. CONTRACTOR SHALL ORDER AND SCHEDULE DELIVERY OF MATERIALS IN AMPLETIME TO AVOID DELAYS IN CONSTRUCTION. IF AN ITEM IS FOUND TO BE UNAVAILABLE, CONTRACTOR SHALL NOTIFY ARCHITECT IMPORTACE TO A LLOW ARCHITECT A REASONABLE AMOUNT OF TIME TO SELECT A REASONABLE SUBSTITUTE.

43. MAKE ALL NECESSARY PROVISIONS FOR ITEMS TO BE FURNISHED OR INSTALLED BY OWNER TEMANT. PROVIDE PROTECTION FOR THESE PROVISIONS UNTIL COMPLETION OF THE PROJECT. GENERAL CONTRACTOR TO COORDINATE N.LC. ITEMS WITH APPROPRIATE TRADES.

45. ABBREVIATIONS USED IN REFERRING TO STANDARDS THAT APPLY TO THE WORK INCLUDE, BUT ARE NOT NECESSARILY LIMITED TO, THE FOLLOWING:

B. AMERICAN INSTITUTE OF STEEL CONSTRUCTION (AISC)
C. AMERICAN WEIGHOS GOSETY (MAS)
D. AMERICAN CONORETE INSTITUTE (AOI)
D. AMERICAN CONORETE INSTITUTE (AOI)
F. ARCHITECTURPAL ALLIMINUM MANUFACTURER'S ASSOCIATION (AAMA)
G. ALLIMINUM ASSOCIATION, INC. (AA)
H. CONORETE REINFORCIANS STEEL INSTITUTE (CRSI)
I. ANTIONIAL ASSOCIATION OF AGRICIAN METAL MANUFACTURERS

NATIONAL ASSULAR IVAN OF PROTITIES LIGHTON MILES ASSULATION (NAMM)
 J. NATIONAL FIRE PROTECTION ASSOCIATION (NFPA)
 K. NATIONAL WOODWORK MANUFACTURER'S ASSOCIATION (NWMA)
 L. WOODWORK INSTITUTE OF CALIFORNIA (WIC)

CAVAGNERO **KUTH**ranieri

Center Recreation Friend Gene

GENERAL NOTES, SYMBOLS, & ABBREVIATIONS

A0.02

SIGNAGE NOTES: ALL SIGNS SHALL COMPLY WITH CBC SECTIONS 11B-216 AND 11B-703 AS APPLICABLE.

- 1. WHEN BOTH VISUAL AND TACTILE CHARACTERS ARE REQUIRED, EITHER ONE SIGN WITH BOTH VISUAL AND TACTILE CHARACTERS, OR TWO SEPARATE SIGNS, ONE WITH VISUAL AND ONE WITH TACTILE CHARACTERS SHALL BE PROVIDED. SIGNS DESIGNATING PERMANENT ROOMS AND SPACES, AND REQUIRED TACTILE EXIT SIGNS, SHALL HAVE BOTH VISUAL AND TACTILE CHARACTERS AND BRAILLE. CHARACTERS SHALL BE RAISED 1/32* MINIMUM AND SHALL BE SANS SERIF UPPERCASE RAISED CHARACTERS SHALL BE SELCTED FROM FONTS WHERE THE WIDTH OF THE UPPERCASE LETTER O IS 60% MIN AND 110% MAX OF THE HEIGHT OF THE UPPERCASE LETTER I. STROKE THICKNESS OF THE UPPERCASE ISHALL BE 15% OF THE HEIGHT OF THE CHARACTER. RAISED CHARACTERS SHALL BE 56" MIN TO 2" MAX IN HEIGHT. TEXT SHALL BE IN A HORIZONTAL FORMAT. CHARACTERS SHALL DE CONTRAST WITH THEIR BACKGROUND, LIGHT ON DARK OR DARK ON LIGHT. CHARACTERS AND THEIR BACKGROUNDS SHALL HAVE A NON-GLARE FINISH. COLORS SHALL BE SELECTED BY THE
- 2. RAISED CHARACTERS SHALL BE DUPLICATED IN BRAILLE BRAILLE SHALL BE CONTRACTED RAISEU CHARMA: IFAS SHALL HAWE A DOMED OR ROUNDED SHAPE AND COMPLY WITH DBC TABLE
 118-703.3.1. THE INDICATION OF AN UPPERCASE LETTER OR LETTERS SHALL ONLY BE USED
 BEFORE THE FIRST WORD OF SENTENCES, PROPER NOUNS AND NAMES, INDIVIDUAL
 LETTERS OF THE ALPHABET, INITIALS AND ACRONYMS, BRAILLE SHALL BE POSITIONED LETTERS OF THE ALPHOMEST, WINTALS AND ACROTIVITIS, OPPLIED STATES DE POSITIONED IN BELOW THE CORRESPONDING TEXT IN A HORIZONTAL FORMAT, FLUSH LEFT OR CENTERED. IF TEXT IS MULTI-LINED, BRAILLE SHALL BE PLACED BELOW THE ENTIRE TEXT. BRAILLE SHALL BE SEPARATED 3/8" MIN AND 1/2" MAX FROM ANY OTHER TACTILE CHARACTERS AND 3/8" MIN FROM RAISED BORDERS OR DECORATIVE ELEMENTS PER SECTION 118-703.3.

WOMEN'S (OR GIRL'S)

DIAMETER

SCREW @ EXTERIOR

3/4" HIGH LETTERS DENOTING

ROOM TITLE, PER FLOOR PLAN

- CA BRAILLE SYMBOLS, TYP, TO


SANITARY FACILITIES, USE A

CIRCLE 1/4" THICK & 12" IN

- 3. THE SIGNS INDICATED ARE FOR CONCEPT & CONTENT ONLY. THE CONTRACTOR SHALL SUBMIT SHOP DRAWINGS TO THE ARCHITECT FOR REVIEW. SHOP DRAWINGS SHALL SHOW EXACT LAYOUT & CONTENT.
- 4. SEE DOOR SCHEDULE FOR SIGN SCHEDULE
- 5 SIGNS SHALL HAVE A NON-GLARE FINISH
- 6. PER SECTION 11B-216.3, SIGNS THAT GIVE DIRECTION TO OR INFORMATION ABOUT INTERIOR OR EXTERIOR SPACES AND FACILITIES SHALL COMPLY WITH THE VISUAL CHARACTER REQUIREMENTS OF SECTION 11B-703.5 LISTED ON A0.27.
- 7. FOR REQUIRED MOUNTING HEIGHT AND LOCATION OF TACTILE SIGNAGE, REFER TO
- FOR REQUIRED MOUNTING HEIGHTS OF VISUAL CHARACTERS REFER TO CBC TABLE 11B-703.5.5.

GEOMETRIC RESTROOM SIGNS

THESE GEOMETRIC SYMBOLS SHALL BE CENTERED ON THE DOOR AT A HEIGHT OF 58" MIN TO 60" MAX TO THE CENTER. THEIR COLORS SHALL CONTRAST WITH THE COLOR OF THE DOOR OR SURFACE ON WHICH THE SYMBOL IS MOUNTED, EITHER LIGHT ON A DARK BACKGROUND OR DARK ON A LIGHT BACKGROUND. AT AN "ALL GENDER" SIGN THE TRIANGLE SHALL CONTRAST WITH THE CIRCLE, WHICH SHALL CONTRAST WITH THE

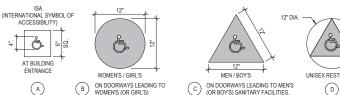


AT NON-ACCESSIBLE TOILET ROOMS

PROVIDE ADDITIONA

DESCRIPTION AS REQ'D

OR OTHERWISE NOTED

&.►

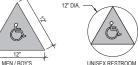

(OR BOY'S) SANITARY FACILITIES,

USE AN EQUILATERAL TRIANGLE

VERTEX POINTING UPWARD

1/4" THICK WITH EDGES 12" LONG &

Ġ

JL - ARROW TO LEFT

J














EXIT

(K)

BRAILLE



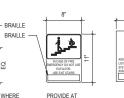

ELEVATORS PER CBC SEC. 3002.3

FOR USE AT EXITS WHERE ILLUMINATED EXIT SIGNAGE IS REQUIRED, MOUNT AT 60" AFF



(M)

3 ACCESSIBILITY SIGNAGE

(H)


2 EXIT ROUTE SIGNAGE

3. EACH EXIT DOOR THAT LEADS DIRECTLY TO A GRADE-LEVEL EXTERIOR EXIT BY MEANS OF AN EXIT ENCLOSURE THAT DOES NOT UTILIZE A STAIR OR RAMP, OR AN EXIT PASSAGEWAY SHALL BE IDENTIFIED BY A TACTILE EXIT SIGN WITH THE WORDS, "EXIT ROUTE."

EACH EXIT ACCESS DOOR FROM AN INTERIOR ROOM OR AREA THAT IS
 REQUIRED TO HAVE A VISUAL EXIT SIGN, SHALL BE IDENTIFIED BY A
 TACTILE EXIT SIGN WITH THE WORDS, "EXIT ROUTE."

5. EACH EXIT DOOR THROUGH A HORIZONTAL EXIT SHALL BE IDENTIFIED BY A TACTILE EXIT SIGN WITH THE WORDS, "TO EXIT."

REFER TO CBC 11B-216.4, 11B-703.1, 11B-703.2, 11B-703.3, & 11B-703.5 FOR SIGNAGE REQUIREMENTS.

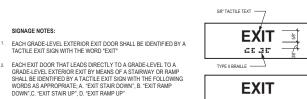

EXIT ROUTE a: a:

EXIT STAIR UP er ar




ACCESSIBILITY GENERAL NOTES

(1) WHERE AN ABSOLUTE DIMENSION IS STATED IN THE CROADA STANDARDS, CONSTRUCTION IS SUBJECT TO CONVENTIONAL MOUSTAY TO CERMICES.
APPLICATION OF CONVENTIONAL MOUSTIET YOU ENANCES SHALL BE ON A CASE SHACE PROJECTS FOR THE CROSS AND DEPEND ON THE OF COMES SHALL BE ON A CASE SHACE BE ON THE OFFICE AND STANDARD SHALL BE CHARDED ON THE CROADA, STANDARDS, NO TOLERANCE SHALL BE PERMITTED OUTSIED OF STATED ON THE CROADA STANDARDS. NO TOLERANCE SHALL BE PERMITTED BUTSIED OF STATED ON THE CROADA STANDARDS, NO TOLERANCE SHALL BE PERMITTED BEYOND THE STATED MINIMAL OR MAXIMAD COCO BIMENSION IS STATED IN THE CROADA STANDARDS, NO TOLERANCE SHALL BE PERMITTED BEYOND THE STATED MINIMAL OR MAXIMAD COCO BIMENSION.

CAVAGNERO

KUTHranieri

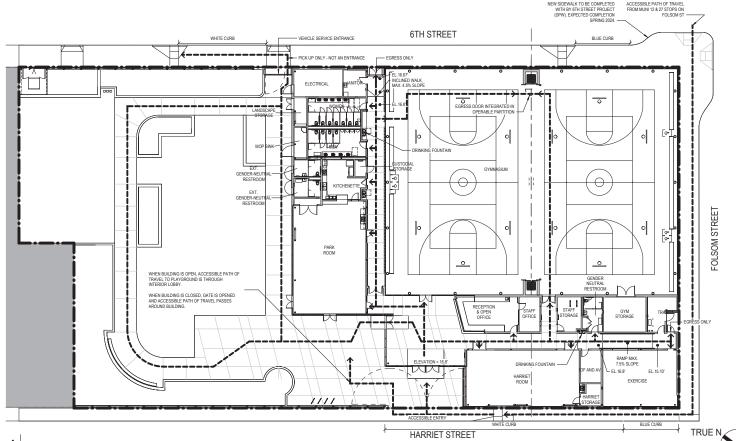



Carla Short Interim Director

DISABILITY ACCESS COMPLIANCE FOR CITY PROJECTS

Building Permit Applicant is to fill in project name + address before scanning this form onto the plan set. For Alterations, add SF DBI checklist & form(s) from Information Sheet DA-02, as applicable.

GENE FRIEND RECREATION CENTER

270 6TH STREET, SAN FRANCISCO 94103

Leave Area Below Blank - for PW-DAC (Disability Access Coordinator) Reviewer Staff Use

DESIGN & PERMIT PHASE: The following elements, if selected, have been reviewed/approved: ☐ PRE-APPLICATION meeting note(s) / SITE PERMIT review only

- ☐ SF DBI DA-02 Checklist / Technical Infeasibility Request form & documentation
- ☐ Accessible Play Areas, Play Components Inventory form
- ☐ Accessible Means of Egress, diagrams indicating components & continuity
- ☐ Scope limited to spaces/elements exempt from accessibility requirements, per 11B-203 ☐ Exempt HVAC, reroofing, electrical or cosmetic work only, not affecting accessibility elements
- ☐ FINAL CONSTRUCTION PLANS for Building Permit applications

CONSTRUCTION PHASE: The following inspections, if selected, are required: Call (628) 271-2942 to schedule inspection(s) with PW-DAC Inspection Staff.

$\begin{tabular}{ll} \hline \begin{tabular}{ll} \hline \begin{tabular}{ll} FRAMING, backing for accessibility elements, plumbing \& electrical rough-in, prior to covering walls \\ \hline \end{tabular}$

- ☐ Formwork for ramps & sloped walkways, prior to concrete-pour
- ☐ Signage, certification of size/spacing of Braille cells/raised text (location mock-up, as necessary) ☐ Door opening force & closing speed (after final air balance, if applicable)
- ☐ Power-Assist & Low-Energy Power-Operated doors, testing & signage per BHMA A156.19
- ☐ Play Area transfer systems, use zones & accessible routes
- ☐ INSPECTIONS AT SUBSTANTIAL COMPLETION, prior to TCO, if applicable ☐ FINAL INSPECTION ON PROJECT, sign-off on SF-DBI Job Card, or letter of acceptance

Arfaraz Khambatta, CASp - Public Works, Disability Access Coordinator


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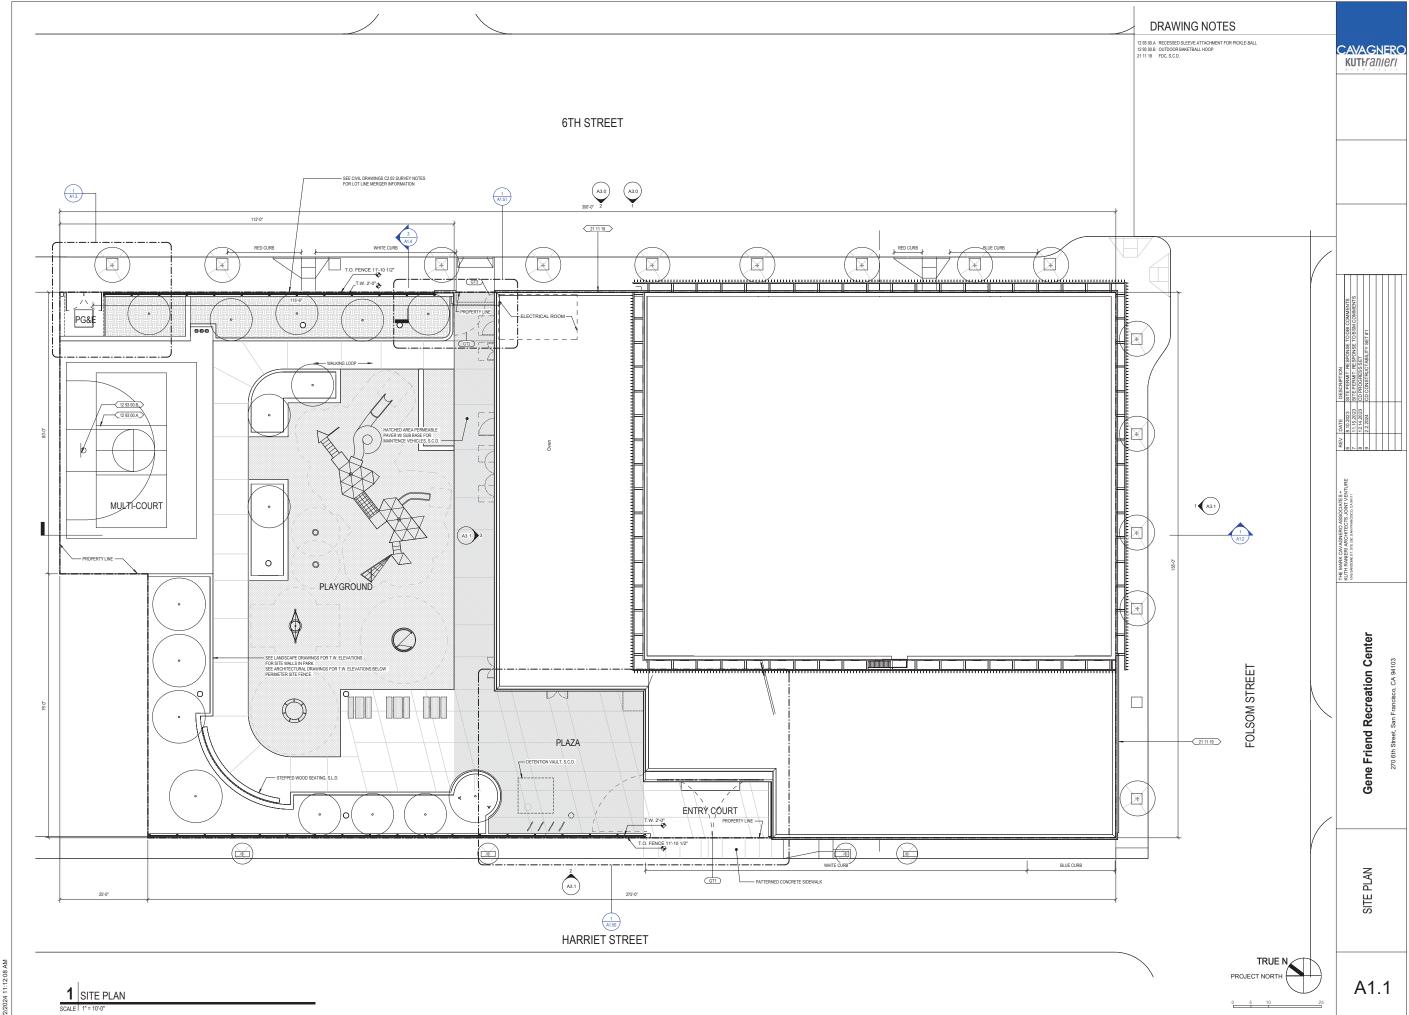
Recreation


Friend

Gene


ACCESSIBLE PATH
OF TRAVEL AND
ACCESSIBILITY
DIAGRAMS



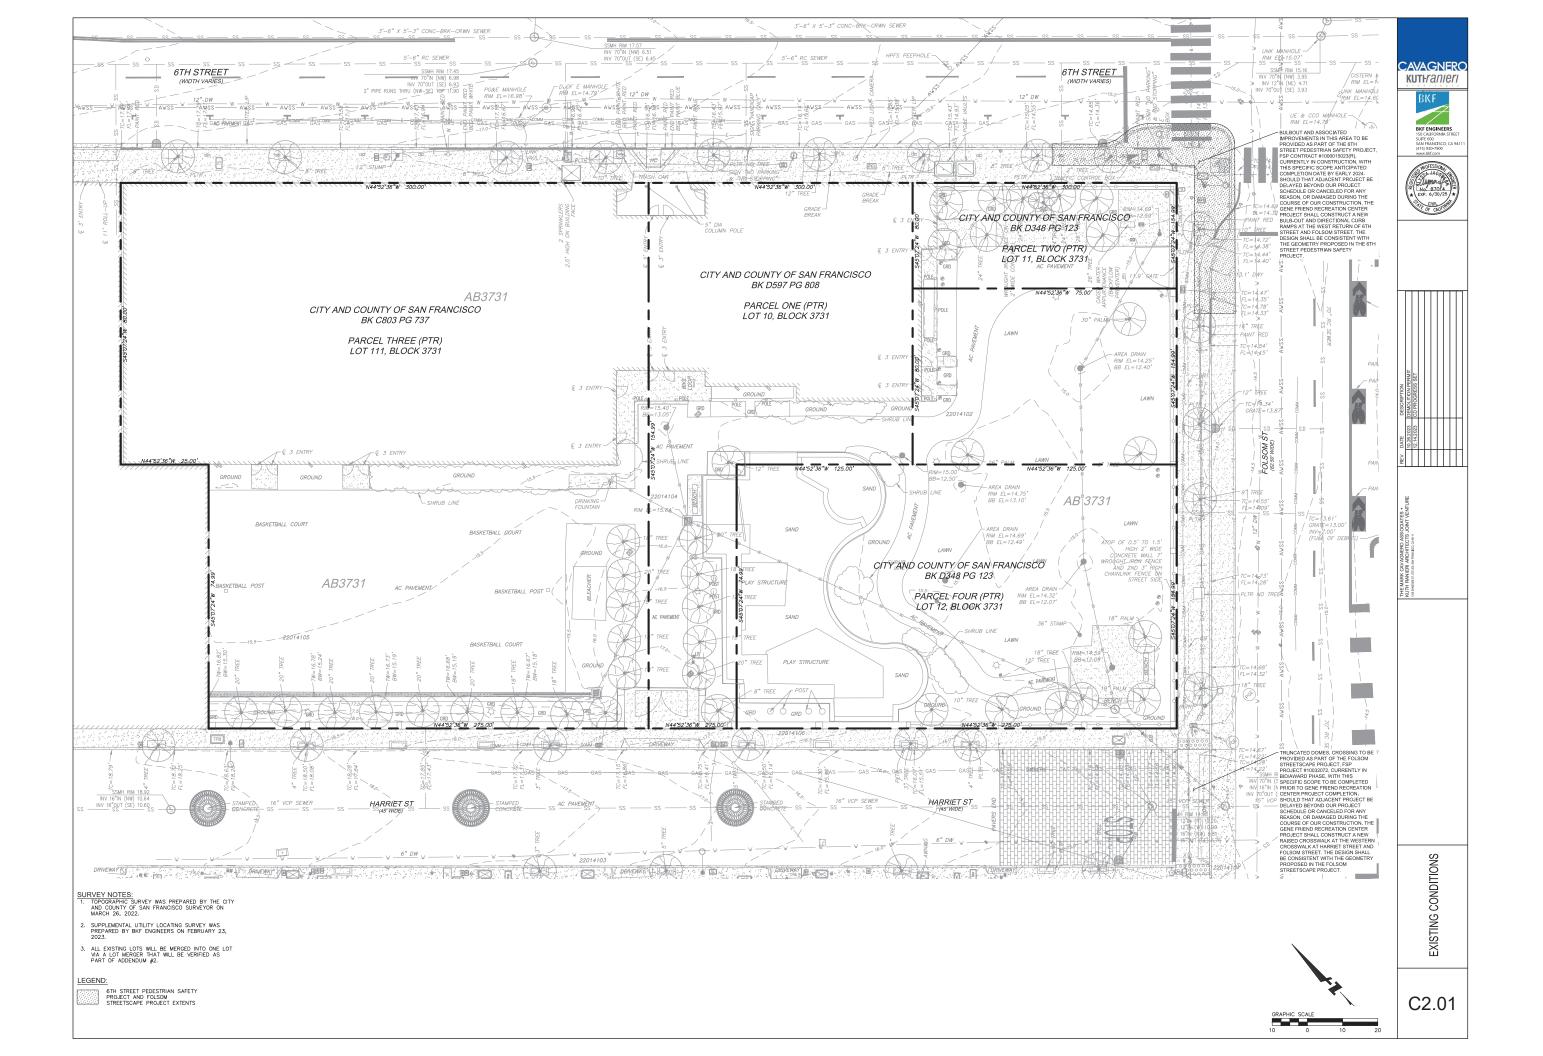


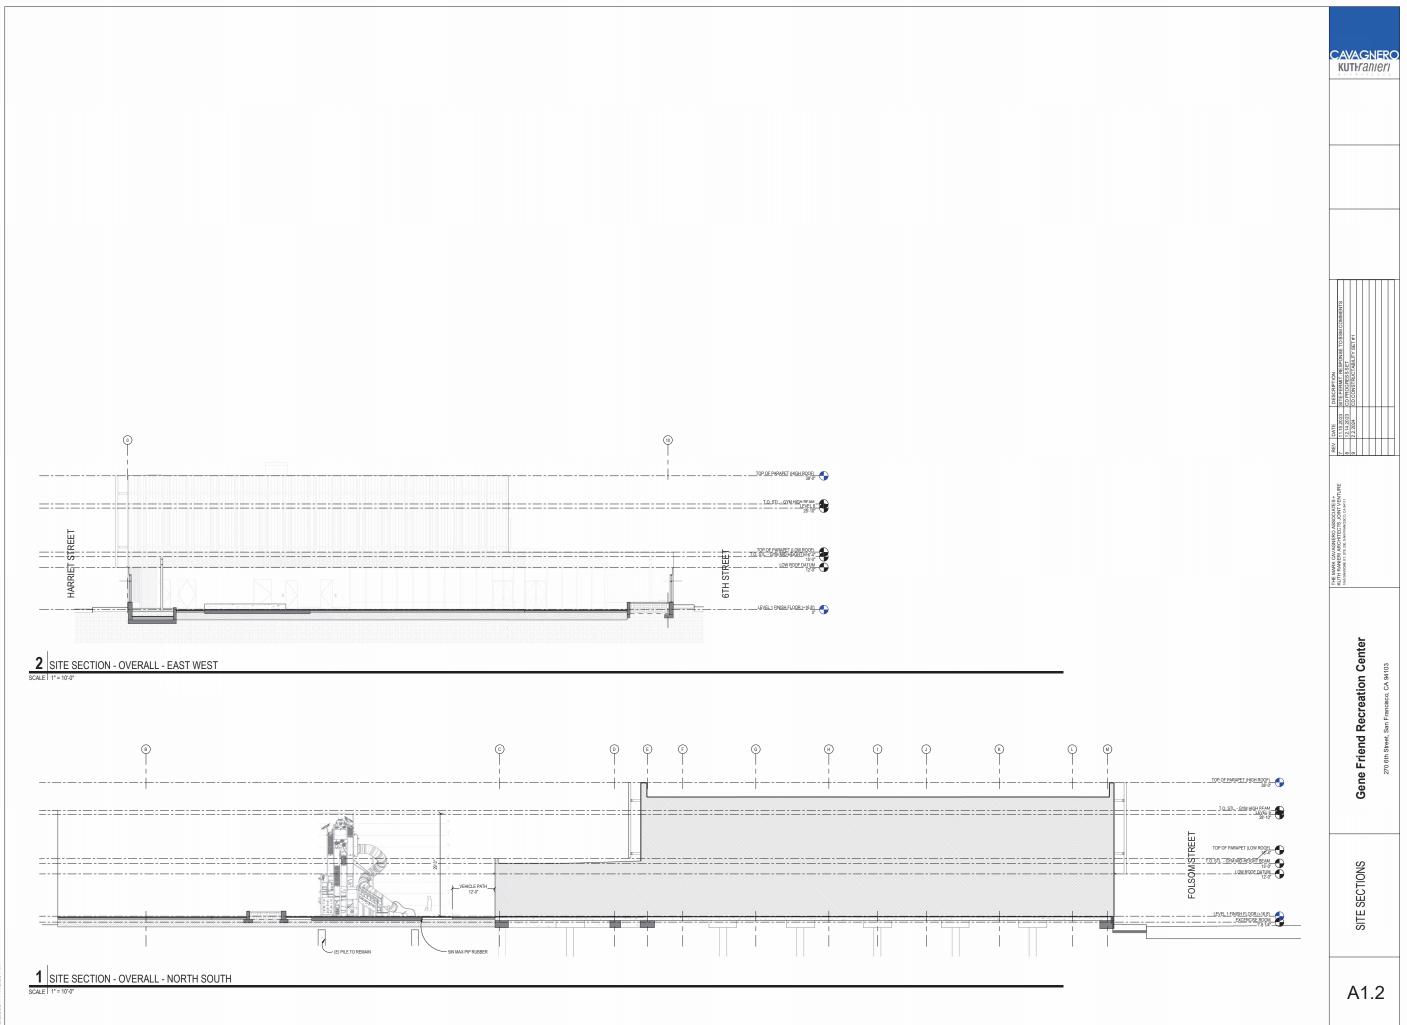


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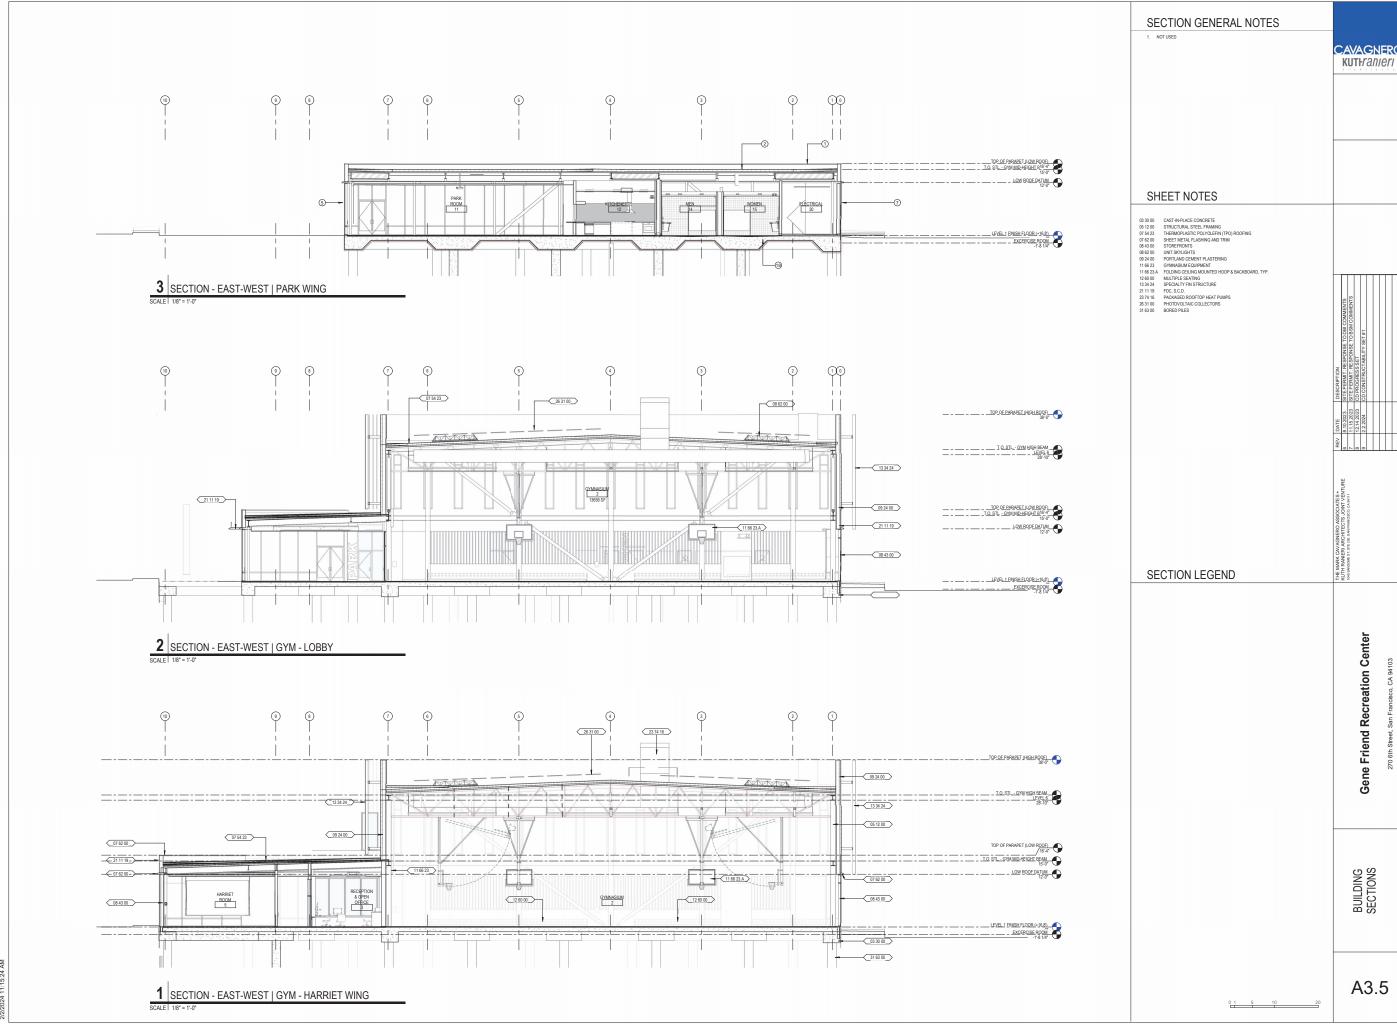

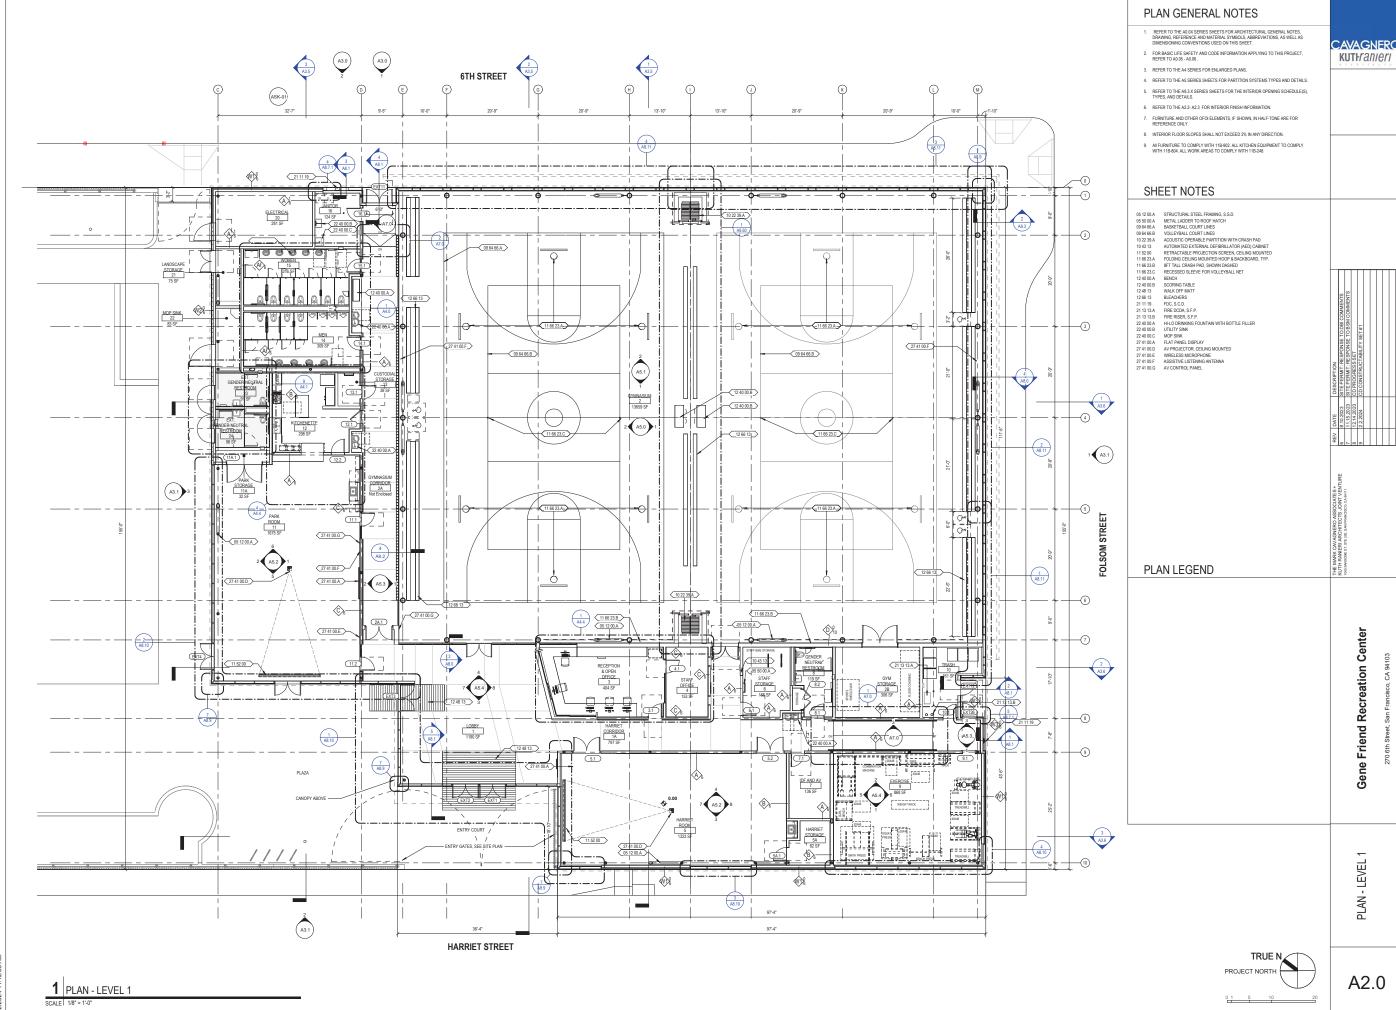
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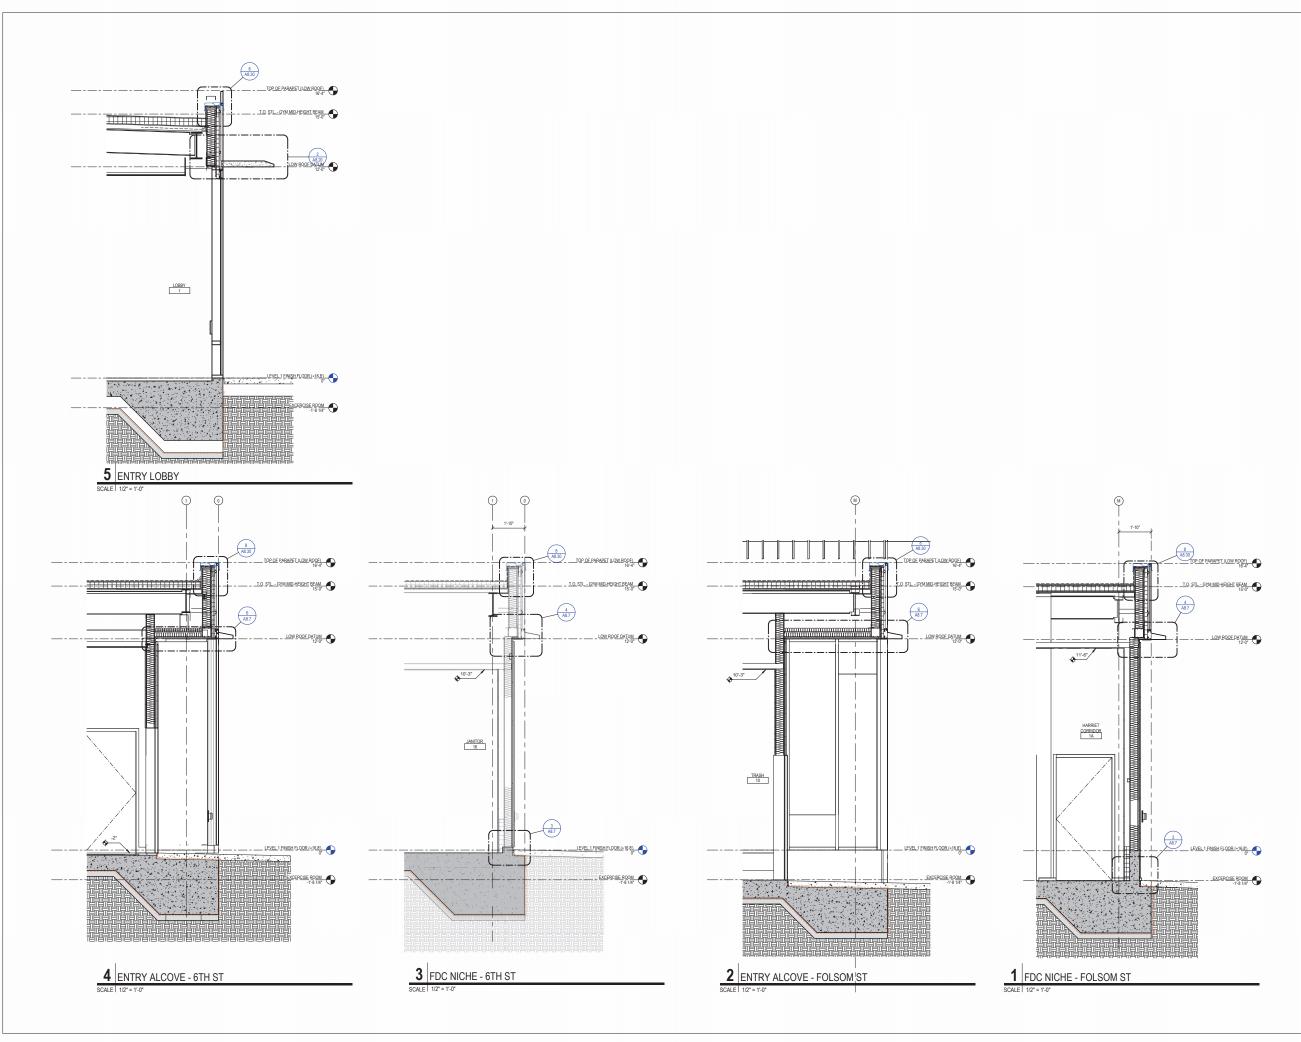


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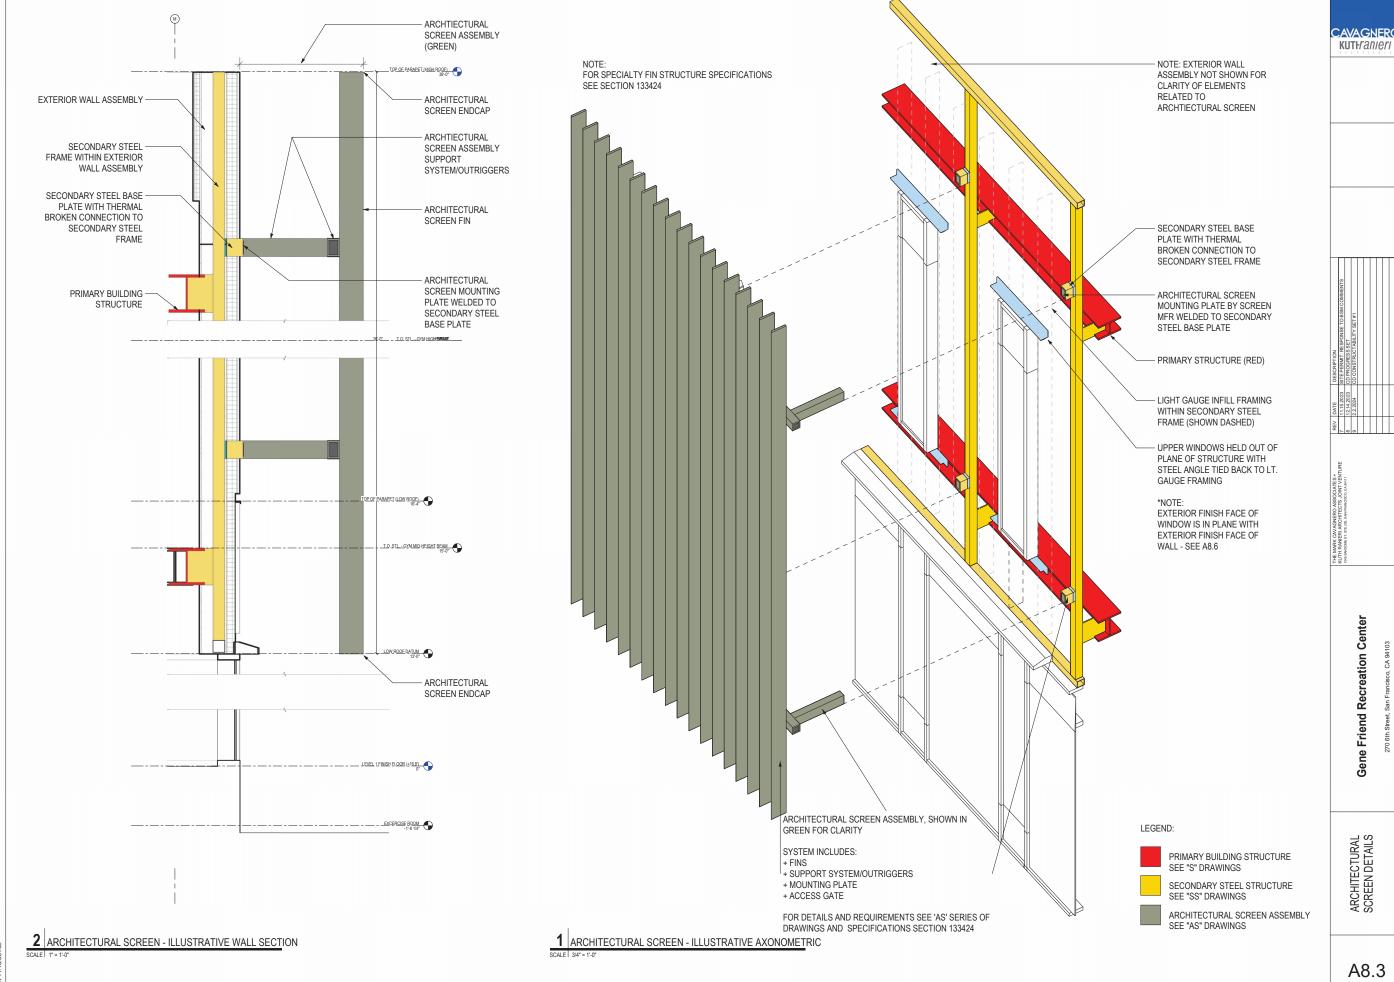
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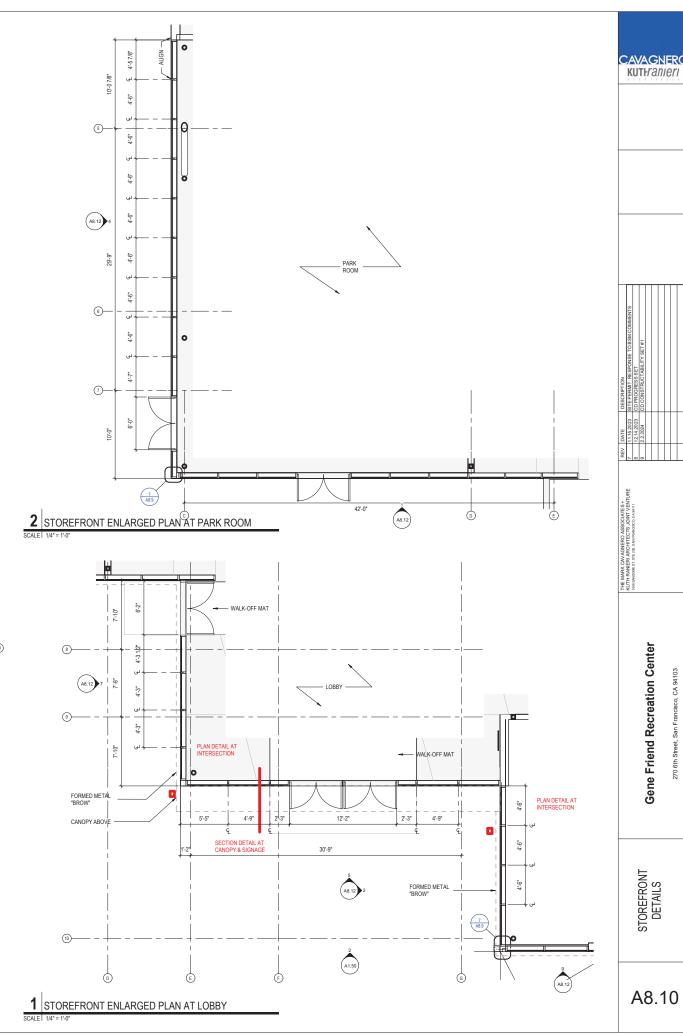
WALL SECTIONS

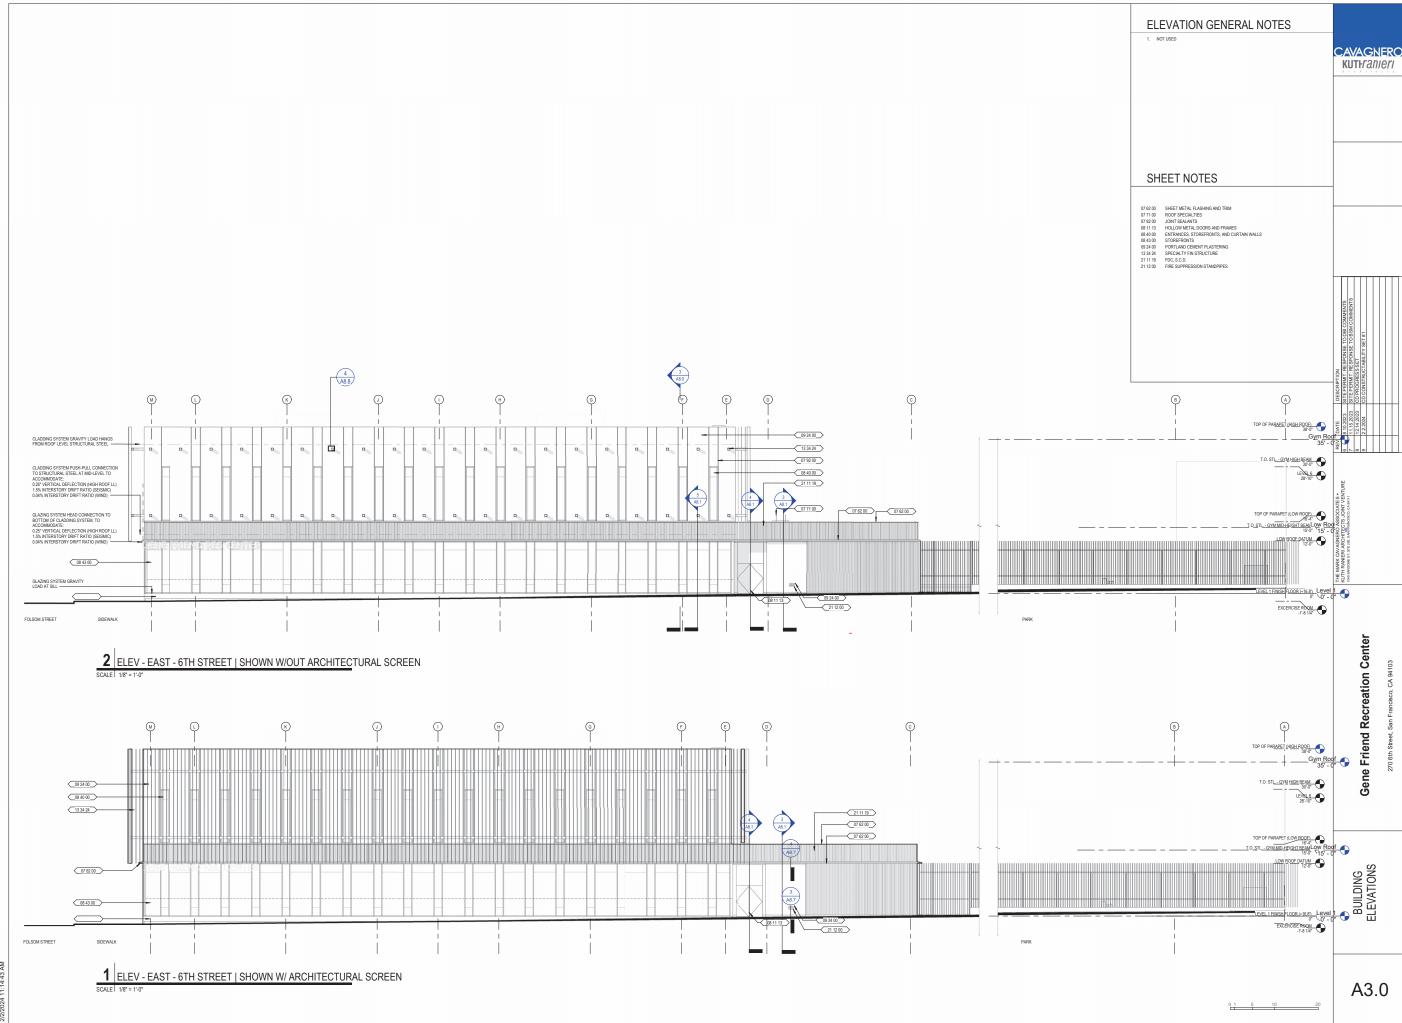
Gene Friend Recreation Center

KUTHranieri

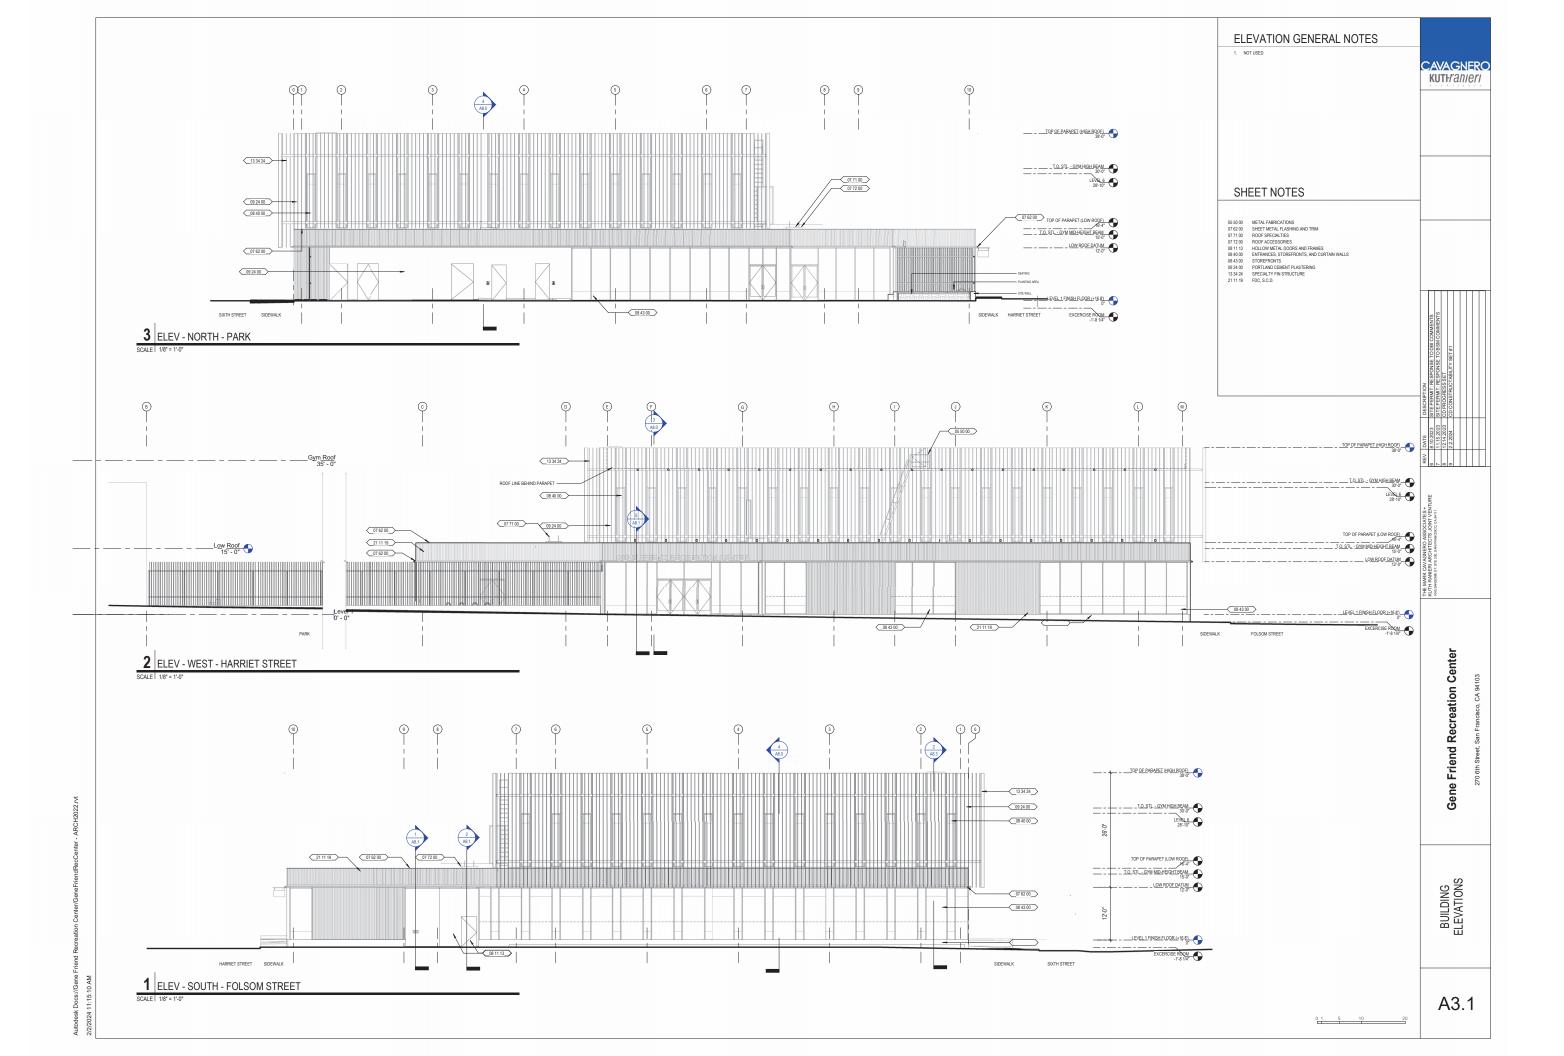


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4 STOREFRONT ENLARGED PLAN AT EXERCISE
SCALE | 1/4" = 1'-0"

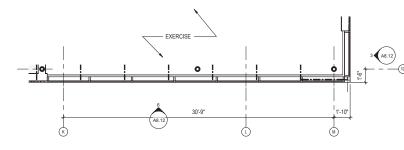

3 STOREFRONT ENLARGED PLAN AT HARRIET ROOM


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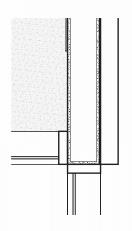
Gene Friend Recreation Center

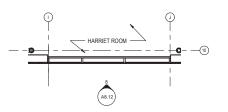LOBBY DETAILS

A9.3



8 LOBBY SOFFIT SECTION DETAIL
SCALE | 3" = 1'-0"

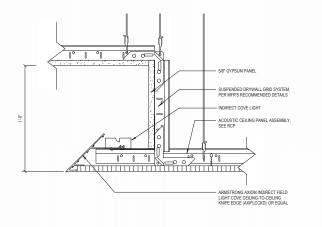

7 Detail 12 SCALE 1 1/2" = 1'-0"




METAL FRAMING, EXTEND TO BOTTOM OF ROOF DECK


3 A9.3


2 A9.3

1 SECTION - RECEPTION DESK

6 3D - LOBBY REFERENCE

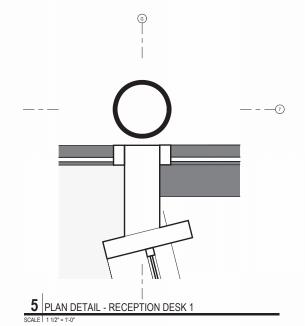

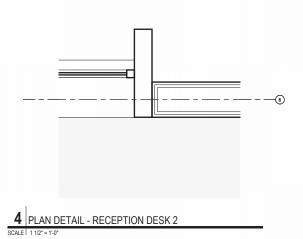

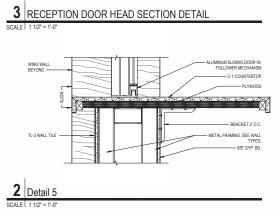



ENTRANCE ON HARRIET STREET



GYM VIEW FROM FOLSOM STREET



FOLSOM STREET ELEVATION

Gene Friend Recreation Center

RENDERINGS

A10.0





GYMANISUM INTERIOR VIEW



GYMNASIUM CORRIDOR

GYMANISUM INTERIOR VIEW



LOBBY

A10.1

RENDERINGS

Gene Friend Recreation Center







PLAYGROUND AERIAL VIEW

PLAYGROUND

Gene Friend Recreation Center

RENDERINGS

A10.2

GENERAL LANDSCAPE NOTES

- THESE NOTES AND LEGEND REFER TO THE LANDSCAPE ARCHITECTURAL "L" DRAWINGS.
- 2. FOR ADDITIONAL NOTES AND LEGEND, REFER TO THE ROADWAY "R"
- THE CONTRACTOR SHALL VERIFY EXISTING GRADES AND SITE CONDITIONS BEFORE PROCEEDING WITH ANY WORK.
- THE LIMIT OF WORK (L.O.W.) OCCURS AT FACE OF BUILDINGS, AT PROPERTY LINES, AT EXISTING FENCES, AND AS SHOWN ON PLANS. THIS LINE, AS DESCRIBED ABOVE. SIDIGRAMMATIC AND IS INTENDED TO DELINEATE LANDSCAPE WORK, FOR ADDITIONAL INFORMATION REGARDING L.O.W. FOR THIS CONTRACT WORK, SEE ROADWAY DOCUMENTS.
- 5. EXISTING CONDITIONS AS SHOWN ON THE DRAWINGS ARE SUBJECT TO DISCREPANCIES AND DO NOT NECESSARILY ACCULARTELY REFLECT THE EXISTING SITE CONDITIONS. CONTRACTOR TO WALK SITE AND FIELD VERIFY ALL EXISTING SITE CONDITIONS PRIOR TO SUBMITTING BIDS.
- ANY REFERENCE IN THE DOCUMENT TO "AS DIRECTED" OR "DIRECTIONS"
 REFER TO DIRECTIONS GIVEN BY THE CITY REPRESENTATIVE/
 LANDSCAPE ARCHITECT.
- ALL WORK TO BE PERFORMED SHALL CONFORM TO ALL APPLICABLE CODES AND ORDINANCES OF GOVERNMENTAL AGENCIES HAVING JURISDICTION OVER THE PROJECT.
- IT SHALL BE THE SOLE RESPONSIBILITY OF THE CONTRACTOR TO PROTECT ALL UTILITIES, IMPROVEMENTS AND STRUCTURES WHETHER SHOWN ON THE DRAWINGS OR NOT AND RESTORE TO NEW CONDITION AS PROVIDED IN THE SPECS.
- THE CONTRACTOR SHALL MAINTAIN ALL GRADES, LINES, LEVELS, AT LOCATIONS AS REQUIRED FOR THE PROPER EXECUTION OF THE WORK.
- 10. THE CONTRACTOR SHALL COORDINATE ALL WORK TO PREVENT CONFLICTS BETWEEN TRADES AND SHALL REPORT CONFLICTS OR INCONGRUITIES BETWEEN NEW IMPROVEMENTS AND/OR EXISTING FACILITIES TO THE CITY REPRESENTATIVE IMMEDIATELY.
- CONTRACTOR RESPONSIBLE FOR PROVIDING ALL QUANTITIES OF MATERIALS SHOWN ON DRAWINGS.
- 12. THE CONTRACTOR SHALL CHECK AND VERIFY THAT ALL SAWCUTTING AND EXCAVATION WORK WILL NOT IMPACT EXISTING SUB-SIDEWALK BASEMENTS AS INCIDENTAL WORK.
- 13. SEE TRAFFIC DWGS. FOR ROADWAY STRIPING PLAN.

LAYOUT NOTES

- ALL TRANSITIONS BETWEEN CURVES AND STRAIGHT EDGES SHALL BE SMOOTH.
- THE CONTRACTOR SHALL VERIFY ALL DIMENSIONS AND SURVEY INFORMATION IN THE FIELD PRIOR TO BEGINNING CONSTRUCTION AND REPORT ANY DISCREPANCIES TO THE CITY REPRESENTATIVE BEFORE PROCEEDING WITH WORK IN THE AREA AFFECTED.
- 3. WRITTEN DIMENSIONS SUPERSEDE SCALED DIMENSIONS.
- 4. ALL DIMENSIONS AT CURB ARE FROM THE BACK OF CURB, UNLESS OTHERWISE NOTED.
- 5. ALL DIMENSIONS SHOWN ARE TO BE TAKEN HORIZONTALLY.
- FOR ADDITIONAL INFORMATION REGARDING LANE STRIPING AND CROSSWALKS, SEE TRAFFIC STRIPING "STR" DRAWINGS.
- 7. THE CONTRACTOR SHALL CONFIRM LOCATION OF SUB-SURFACE UTILITIES AND INFRASTRUCTURE.
- THE CONTRACTOR SHALL ALIGN ALL NEW AND EXISTING UTILITY BOXES
 AND VAULTS WITH CONCRETE PAVING PATTERN AS MUCH AS POSSIBLE.
- ADJUST (E) UTILITY BOXES TO BE SQUARE WITH NEW SIDEWALK PAVING ALIGNMENT AS MUCH AS POSSIBLE.
- 10. TRANSIT SHELTER PANEL TO BE INSTALLED BY SFMTA. LOCATION TO BE VERIFIED WITH CITY REPRESENTATIVE.
- 11. EXACT LOCATION OF ALL SITE FURNISHINGS TO BE DETERMINED BY CITY REPRESENTATIVE REFORE INSTALL ATION.
- 12. SEE TRAFFIC DWGS FOR ROADWAY STRIPING PLAN.

GRADING & SOIL PREP. NOTES

- SEE ROADWAY DRAWINGS FOR GRADING INFORMATION.
- SEE SPECIFICATIONS FOR COMPLETE PLANTING PIT BACK FILL.

PLANTING NOTES

- 1. SEE SPECIFICATIONS FOR FULL PLANTING INFORMATION
- PLANT LIST IS FOR THE CONVENIENCE OF THE CONTRACTOR. IN CASE OF DISCREPANCIES, THE PLAN SHALL GOVERN.
- CONTRACTOR SHALL REVIEW PLANT LOCATIONS WITH THE CITY REPRESENTATIVE PRIOR TO PLANTING.
- THE CITY REPRESENTATIVE RESERVES THE RIGHT TO MAKE SUBSTITUTIONS, ADDITIONS, OR DELETIONS IN THE PLANTING SCHEME AS THE WORK PROGRESSES.
- 5. ALL PLANT MATERIAL SHALL BE INSPECTED PRIOR TO PLANTING. CONTRACTOR SHALL REVIEW ALL PLANT MATERIAL ON SITE WITH CITY REPRESENTATIVE AND INSTALL MATERIAL ONLY AFTER OBTAINING WRITTEN APPROVAL FROM THE CITY REPRESENTATIVE; SEE SPECIFICATION 32 90 00.

ABBREVIATIONS

C PPROX. C. LDG. O. C. C. LDG. O. O. C. S. O.W. CSF ONC. OND. ONT. J. IA. WG J. A. J. C.	CITY & COUNTY OF SAN FRANCISCO CENTER LINE COMCRETE CONDITION CONTROL JOINT DIAMETER DRAWING EXISTING EACH EXPANSION JOINT EQUAL EXPANSION JOINT EQUAL EXPANSION FINISH GRADE FACE OF BUILDING FACE OF CURB FINISH SURFACE FEET GALVANIZED HIGHEST POINT	MFR. MANUF. (N) N.I.C. NO. N.T.S. O.C. O.C.S. O.D. P.A. P.O.B. R. RDWY REF. REQ'D SECT. SHT. SIM. S.J. S.E.D. S.W.D. SPECS. STA. PT. ST. STD. ST. STL.	NOT IN CONTRACT NUMBER NOT TO SCALE ON CENTER OVERHEAD CONTACT SYSTEM OUTSIDE DIAMETER PLANTING AREA POINT OF BEGINNING RADIUS RADIUS REFERENCE RECUIRED SECTION SHEET SIMILAR SCORE, JOINT SEE ELECTRICAL DWGS SEE BECTRICAL DWGS SEE SEWATER DEPT. DWGS STATION POINT STREET STANDARD STALING POINT STREET STANDARD
l.	INCHES		TELEPHONE PULL BOX
Γ.	JOINT		TRASH RECEPTACLE
J.	KEYED CONSTRUCTION JOINT		TYPICAL
O.W.	LIMIT OF WORK	U.O.N.	UNLESS OTHERWISE NOTED
AX.	MAXIMUM		VERIFY IN FIELD
		V.I.F.	






ANTE DEBORPTON
122.222 50% DESIGN DEVELOPMENT
23.22.223 10% DESIGN DEVELOPMENT
24.2223 10% DEVOGRESS BET
12.4.2223 10 PROGRESS BET


THE MARK CAVAGNERO ASSOCIATES +
KUTH RANIERI ARCHITECTS JOINT VENTURE
1016 SANISOMIET, SIIT 200, SANIFRANDSCO, CA BAIRT

Gene Friend Recreation Center

NOTES & ABBREVIATIONS +

L-0.0

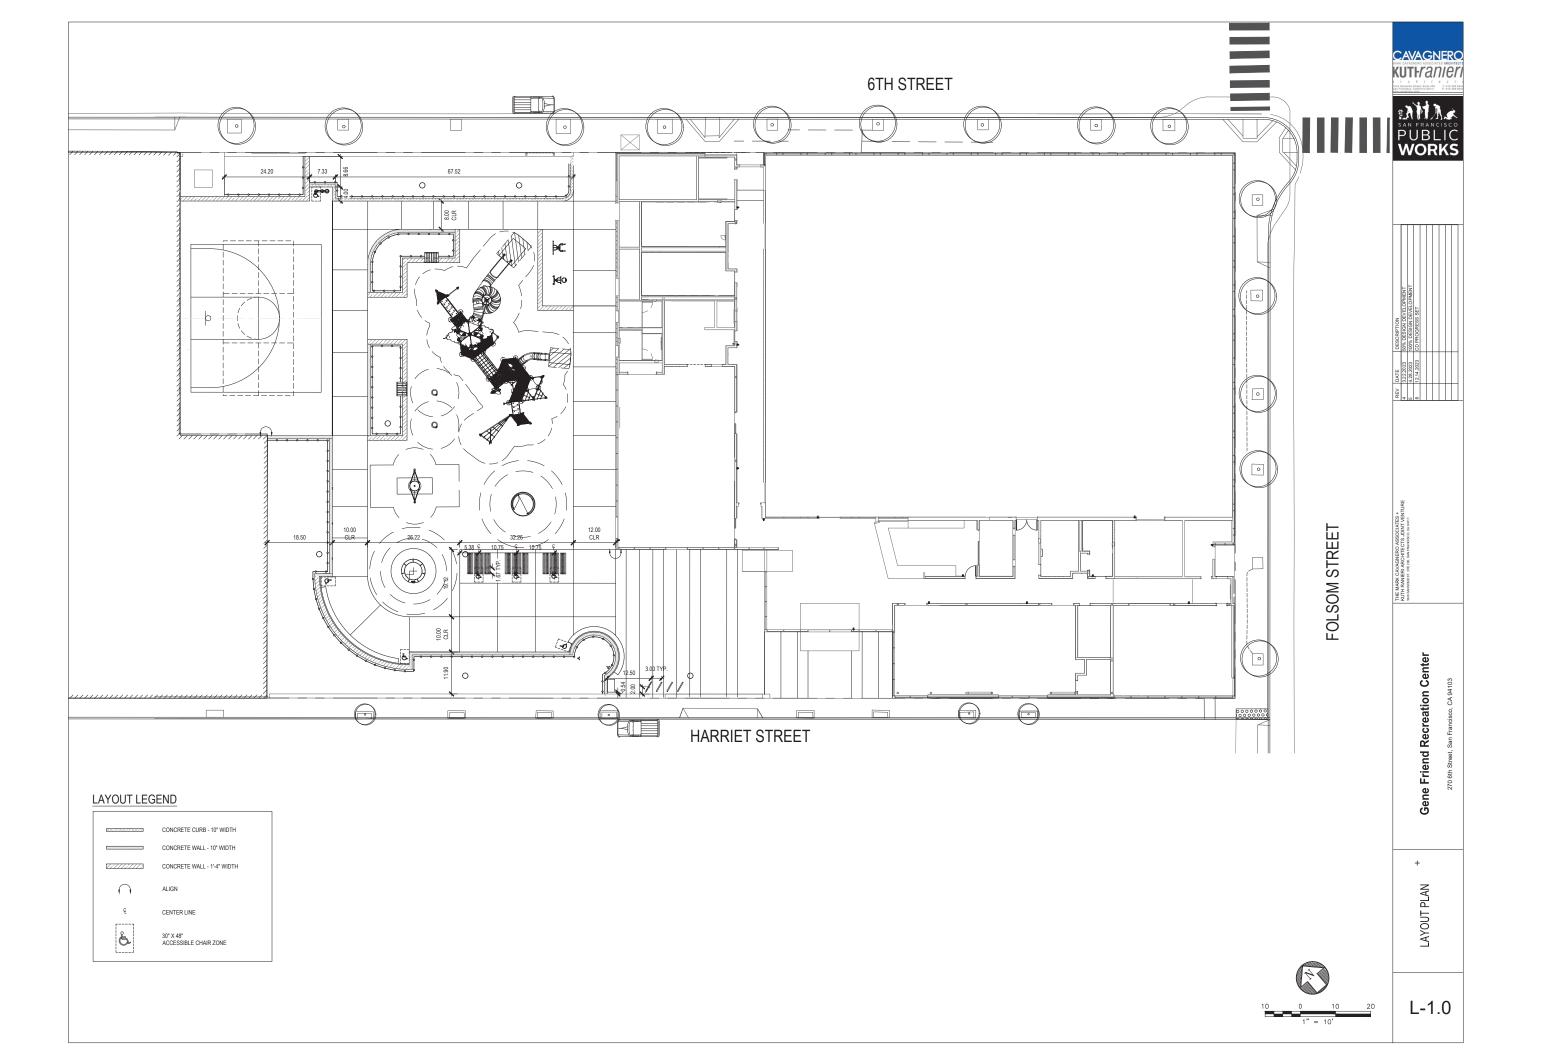

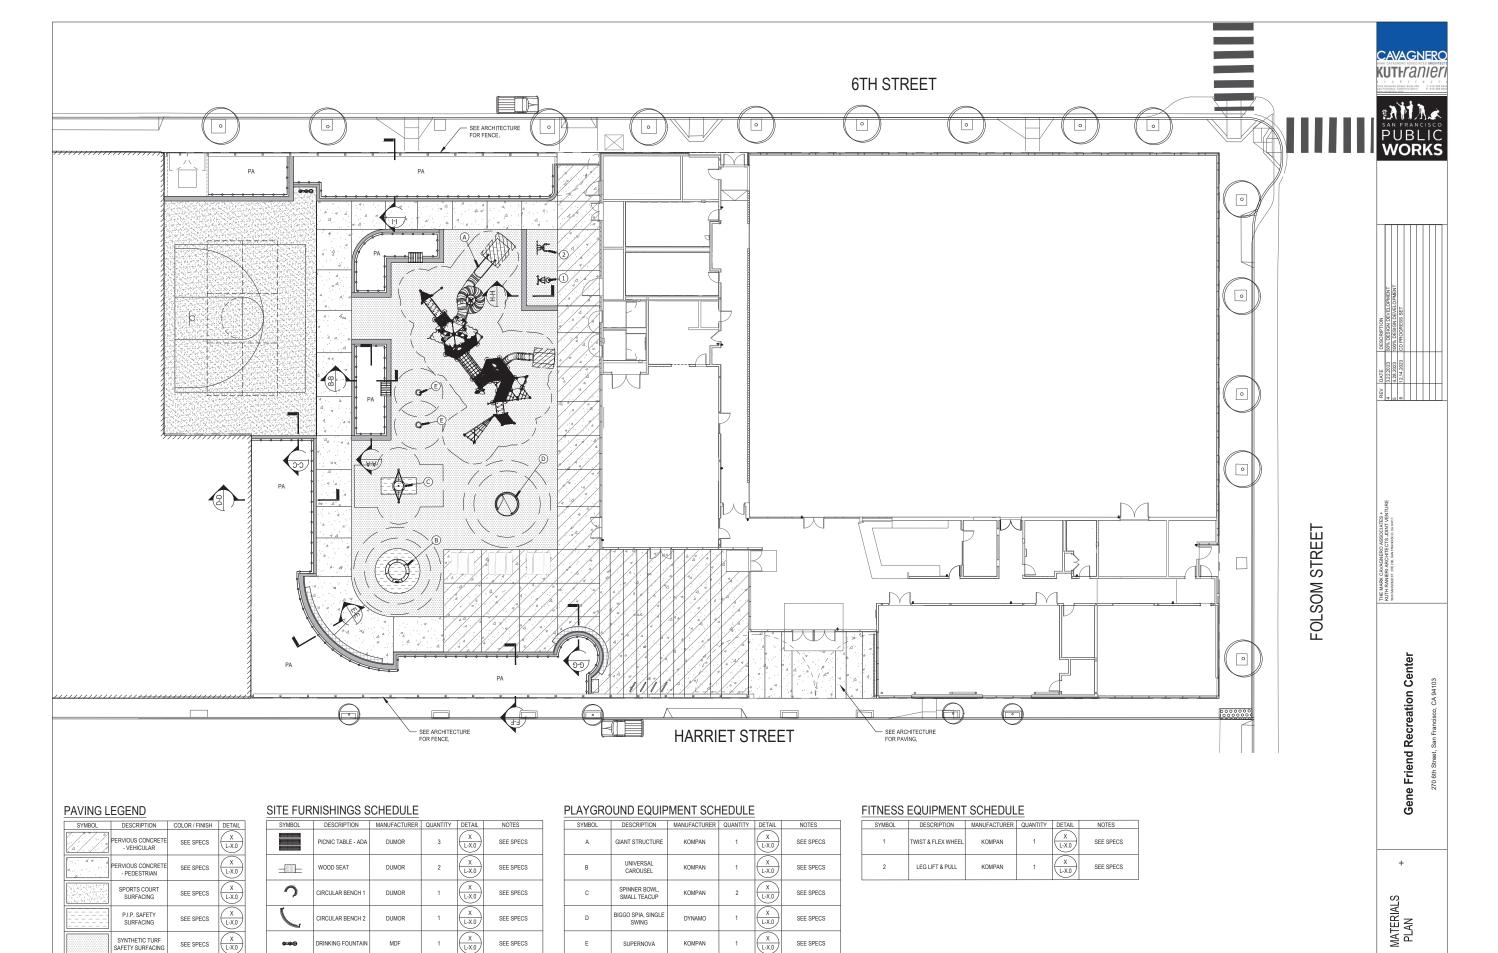

BIKE RACK

TRASH RECEPTACLE

ROPE AND STAKE

BEARSAVER

403 LF


PLANTING AREA

SEE SPECS

SEE SPECS

SEE SPECS

SEE SPECS

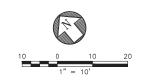

TREE S	SCHEDULE					
CODE	BOTANICAL NAME	COMMON NAME	SIZE	WATER USE	QTY	REMARKS
LYO FLO	LYONOTHAMNUS FLORIBUNDUS ASPLENIFOLIUS	FERNLEAF CATALINA IRONWOOD	24" BOX	L	4	2-2.5" DBH; MATCHED HEIGHT AND CANOPY
MAG LIT	MAGNOLIA GRANDIFLORA 'LITTLE GEM'	LITTLE GEM DWARF SOUTHERN MAGNOLIA	24" BOX	М	6	2-2.5" DBH; MATCHED HEIGHT AND CANOPY
OLE WIL	OLEA EUROPAEA 'WILSONII'	WILSON OLIVE	24" BOX	L		MULTI-TRUNK; DENSELY BRANCHED; MATCHED SIZE; MIN. 5'-0" HEIGHT
STREET TREE	S					
TIL COR	TILIA CORDATA	LITTLELEAF LINDEN	24" BOX	М	1	2-2.5" DBH

PLANT	SCHEDU	LE					
SYMBOL SHRUBS	CODE	BOTANICAL NAME	COMMON NAME	SIZE	WATER USE	SPACING	QTY
0	ARC ECP	ARCTOSTAPHYLOS X 'EMERALD CARPET'	EMERALD CARPET MANZANITA	5 GAL.	М	72" o.c.	7
\odot	ARC LKP	ARCTOSTAPHYLOS X 'LUTSKO'S PINK'	LUTSKO'S PINK MANZANITA	5 GAL.	L	60" o.c.	14
0	ART PYC	ARTEMISIA PYCNOCEPHALA 'DAVID'S CHOICE'	DWARF COASTAL BEACH SAGEWORT	5 GAL.	L	24" o.c.	62
\odot	BAC PIG	BACCHARIS PILULARIS 'PIGEON POINT'	PIGEON POINT COYOTE BRUSH	5 GAL.	L	36" o.c.	14
\bigcirc	BAC PEA	BACCHARIS PILULARIS 'TWIN PEAKS'	TWIN PEAKS COYOTE BRUSH	5 GAL.	L	72" o.c.	9
0	PHL TTW	PHLOMIS PURPUREA 'ALBA'	WHITE PHLOMIS	5 GAL.	L	48" o.c.	34
(+)	SAL PER	SALVIA NEMOROSA	MEADOW SAGE	5 GAL.	М	18" o.c.	203
FLOW-THROUG	H PLANTER						
+	CER OCC	CERCIS OCCIDENTALIS	WESTERN REDBUD	15 GAL.	М	144" o.c.	4
(+)	DES TUF	DESCHAMPSIA CESPITOSA	TUFTED HAIR GRASS	5 GAL.	н	24" o.c.	51
\bigcirc	DIP AUR	DIPLACUS AURANTIACUS	STICKY MONKEYFLOWER	5 GAL.	L	24" o.c.	47
₹ • }	JUN PAT	JUNCUS PATENS	CALIFORNIA GRAY RUSH	5 GAL.	М	24" o.c.	51
0	SAL SPA	SALVIA SPATHACEA	HUMMINGBIRD SAGE	5 GAL.	L	30" o.c.	15
GROUND COVE	RS						
	ACH MIL	ACHILLEA MILLEFOLIUM	COMMON YARROW	1 GAL.	М	18" o.c.	116
	FRA GR4	FRAGARIA CHILOENSIS 'GREEN PASTURES'	GREEN PASTURES BEACH STRAWBERRY	1 GAL.	М	12" o.c.	116
	IRI CA3	IRIS DOUGLASIANA PCH 'CANYON SNOW'	CANYON SNOW IRIS	1 GAL.	М	18" o.c.	66






32.2023 GW DESIGN DEVELOPMENT 42.2023 GW DESIGN DEVELOPMENT 12.1.2023 CD PROCRESS SET							
	DESCRIPTION	50% DESIGN DEVELOPMENT	100% DESIGN DEVELOPMENT	CD PROGRESS SET			
	DATE		П				


THE MARK CAVAGNERO ASSOCIATES +
KUTH RANIERI ARCHITECTS JOINT VENTURE
1908 SWISOLIET, SIII 200, SWIFINICISCO CV 84111


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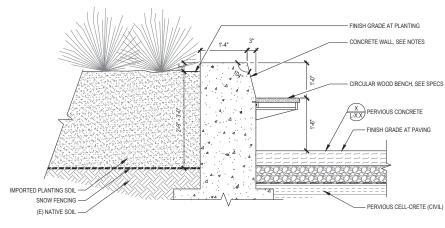
PLANTING SCHEDULE





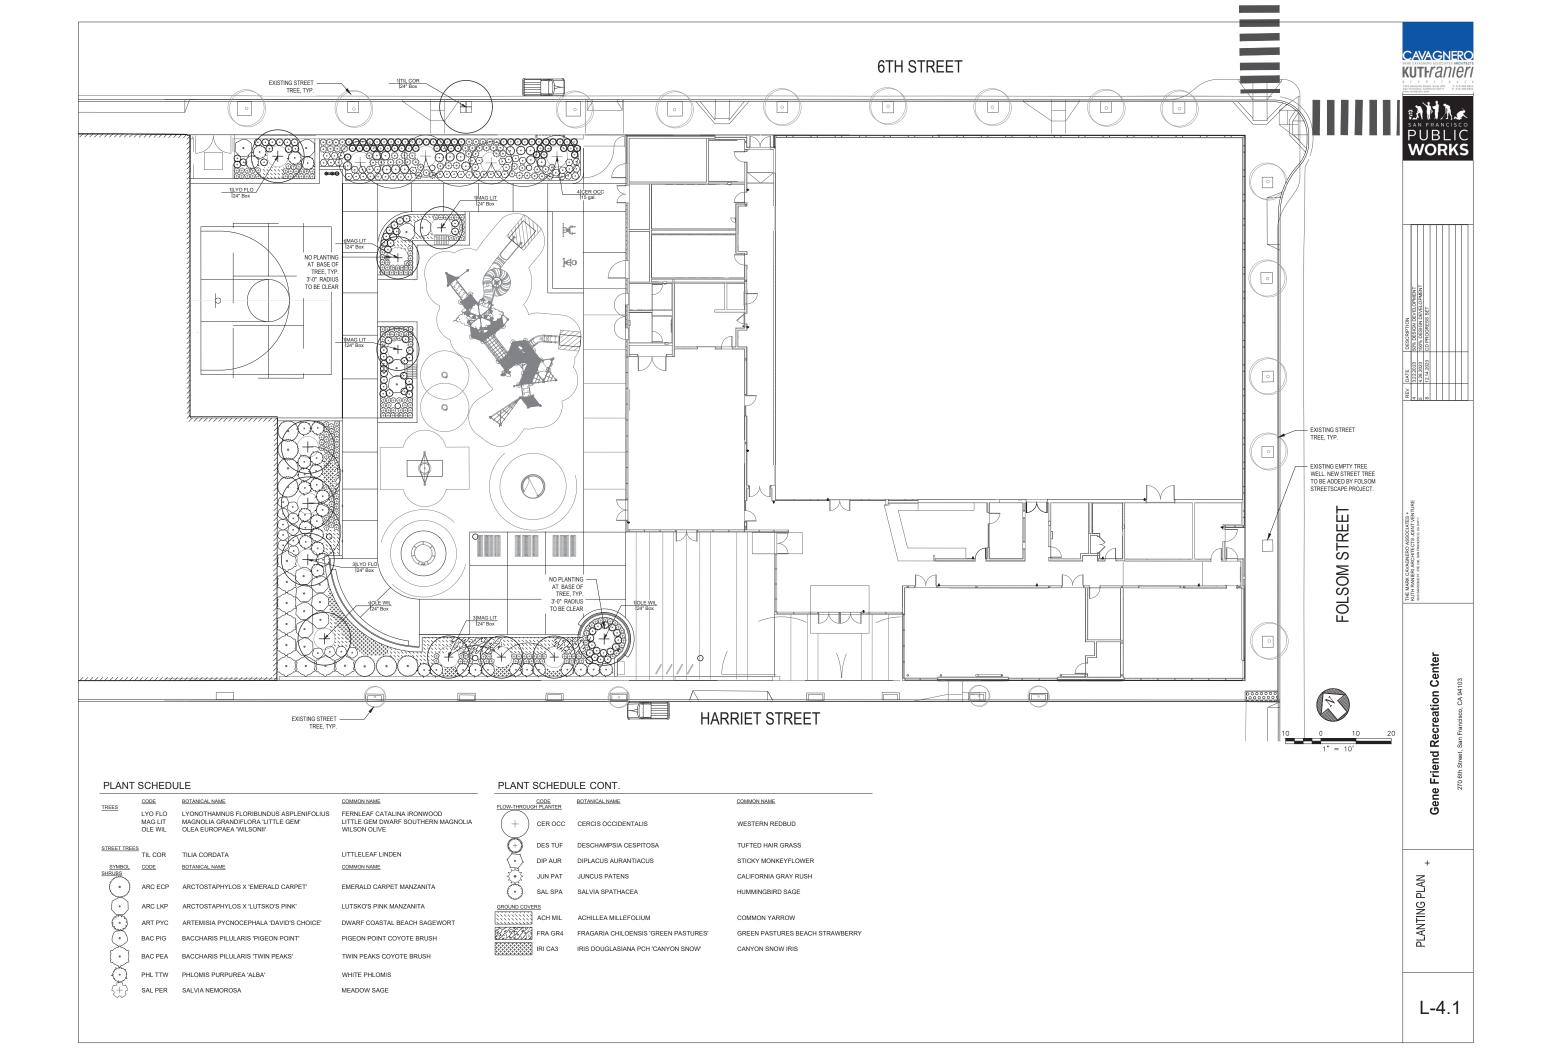

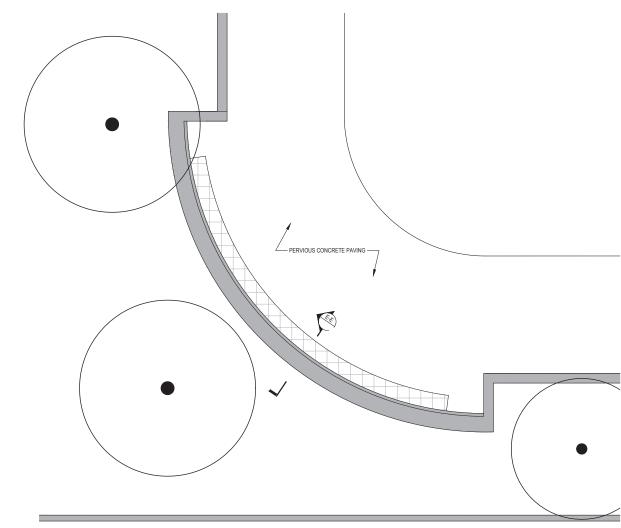REFERENCE PLAN N.T.S

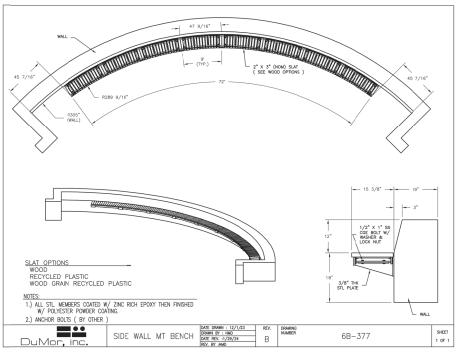

SECTION/ELEVATION

- NOTES:

 1. ALL EXPOSED VERTICAL SURFACES TO RECEIVE STANDARD FORM FINISH. SEE SPECS.

 2. ALL EXPOSED HORIZONTAL SURFACES TO RECEIVE LIGHT BROOM FINISH, PERFENDICULAR TO WALL.

 3. SEE STRUCTURAL X DETAIL BELOW FINISH GRADE AND FOR WALL REINFORCEMENT REQUIREMENTS.

 4. SEE CIVIL FOR CELL-CRETE.

SECTION E-E - TERRACED SEATING

PUBLIC **WORKS**

CAVAGNERO **KUTH**ranieri

Gene Friend Recreation Center

CONSTRUCTION DETAILS








CONSTRUCTION DETAILS



- FINISH GRADE AT PAVING

- SURFACE-MOUNT PER MANUFACTURER'S REQUIREMENTS - CONCRETE FOOTING


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- WOOD SLATS X CONCRETE WALL

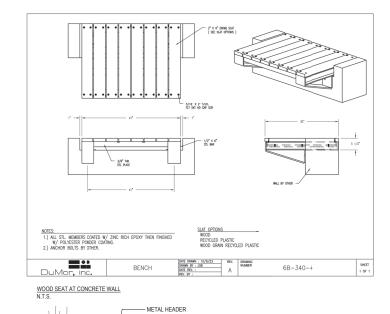X POURED-IN-PLACE SURFACE

- FINISH GRADE AT PAVING



______ X PERVIOUS CONCRETE SECTION/ELEVATION

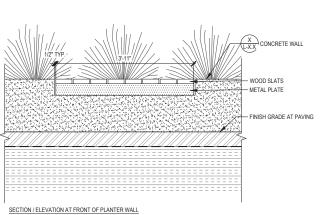1/2" II 1" SSIL COX BOX 564 TOO! SA!

ADA PICNIC TABLE N.T.S.

2 WOOD SEAT/PLATFORM AT PLANTER WALL

SECTION